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Chapter 90 Funding Request – Conwell Street Project

Requested by: Richard J. Waldo, Public Works Director

Action Sought: Discussion & Approval

Proposed Motions

Move that the Board of Selectmen vote to authorize the Public Works Director to submit a Project Request form to Massachusetts Department of Transportation for use of chapter 90 funding in the amount \$745,140 for Bid Phase Engineering Services and Construction Costs as it relates to the Conwell Street Bicycle and Pedestrian Improvement Project.

Additional Information

The Massachusetts Department of Transportation reimburses cities and towns for costs incurred for eligible transportation projects through the Chapter 90 program. Chapter 90 funding is distributed to cities and towns through a formula that takes into account population, road miles and employment.

Currently the Town of Provincetown has an uncommitted balance of approximately \$833,496 in Chapter 90 funding. It is anticipated that the Town would use approximately \$745,140 of the available Chapter 90 funding for this Conwell Street Bike and Pedestrian Improvement Project.

The Massachusetts Department of Transportation approved the 100% Design for this project, and issued a Road Access Permit. This request is to authorize the Public Works Director to proceed with acquiring bid documents, advertising the project, and accepting bids in accordance with Chapter 90 requirements. Upon the receipt of acceptable bids, the contract will be awarded, and the construction phase of this project will commence.

It is the intention to use Chapter 90 funds for all of the costs of this project.

Additional information and Chapter 90 request form attached.

Board Action					
Motion	Second	In favor	Opposed	Disposition	

TOWN OF PROVINCETOWN

Department of Public Works

Highway Division
Water & Sewer Division
Buildings & Grounds Division
Transfer Station/Recycling Center
Sanitation Division
Cemetery Division

Richard J. Waldo, Director Steven H. Wlodkowski, Deputy Director Cody J. Salisbury, Water Superintendent Sherry Prada, Operations Director Robert Capurso, Town Engineer



Veterans Memorial Community Center 2 Mayflower St., Room 74

Mail: 260 Commercial Street Provincetown MA 02657 Phone: 508.487.7060 FAX: 508.487.4675 http://www.provincetown-ma.gov

rwaldo@provincetown-ma.gov swlodkowski@provincetown-ma.gov csalisbury@provincetown-ma.gov sprada@provincetown-ma.gov rcapurso@provincetown-ma.gov

September, 2020

Mr. Sean M. Sullivan, Acting State Aid Manager Massachusetts Department of Transportation, District 5 Office 1000 County Street Taunton, MA 02780

Re: Chapter 90 Project Requests- Conwell Street Rehabilitation

Dear Mr. Sullivan:

Attached herein is the Chapter 90 Project Request form for construction, and engineering bid and construction phase services associated with the Conwell Street Rehabilitation Project.

The project will provide a road diet along Conwell Street, repurposing the heavily trafficked roadway from a two-lane roadway to a two-directional roadway with designated bike lanes on each side, and one sidewalk on the West side. The designated bike lanes and separate sidewalk will provide for safe bicycle and pedestrian accommodations that will connect Route 6 and Race Point Road to Conwell Street. Race Point Road connects to bike trails and recreational spaces within the National Seashore area. There are proposed bike lanes along Route 6 in this area. The majority of the existing roadbed will be reused with areas of transitioning to meet existing alignments to minimize construction costs and impacts. Work includes tying new bike lanes and new sidewalk into existing driveways, installing ADA compliant fixtures and grading in new sidewalk, narrowing vehicular travel lane width, landscape features, pavement markings, minor drainage alternations, traffic calming features, and the provision of safety controls/signing for construction operations.

We are requesting \$745,140 in Chapter 90 funding for the construction, and engineering bid and construction phase services associated with the above Conwell Street rehabilitation.

Please do not hesitate to contact me at (508) 487-7060 should you have any questions or require additional information. I can also be reached via e-mail at rwaldo@provincetown-ma.gov.

Very truly yours,

Richard J. Waldo, P.E.

Director of Public Works, Provincetown

Attachments: Chapter 90 Project Request Form

	CHAPTER 90 – PROJECT REQUEST 8/2012 updated
*2 Original Signed Proj	ject Request Forms are to be submitted. CONTRACT #
Classification: <u>Urban</u>	n Principal Arterial
Primary Road: Conw	vell Street
Local Road: Cemet	etery Rd, Old Ann Page Way, Hensche Lane, Off Conwell St
City/Town: Province	acetown
	ll Street between Route 6 and Cemetery Road
· · · · · · · · · · · · · · · · · · ·	Length: 910 Feet Width: 35 feet
PROJECT TYPE Construction: Other:	Resurfacing: Engineering: Equipment:
TYPICAL SECTION Construction/Improvem	N DETAILS: Indicate depths, special treatments, etc Also please include sketch for nent Projects.
Surface:	Drawings C1-C7 (Environmental Partners Group)
Base Course:	Drawings C1-C7 (Environmental Partners Group)
Foundation:	N/A
Shoulders/Sidewalks:	Drawings C1-C7 (Environmental Partners Group)
SCOPE OF WORK:	
Construction Costs owned Conwell Street, repudirectional roadway designated bike land accommodations the connects to bike trabike lanes along Routransitioning to meet tying new bike lanes	reparing Bid Documents by Environmental Partners Group, and subsequent by contractor (tbd), based on approved MassDOT 100% engineered design of Towneet from Route 6 to Cemetery Road. The project will provide a road diet along burposing the heavily trafficked roadway from a two-lane roadway to a two-y with designated bike lanes on each side, and one sidewalk on the West side. The nes and separate sidewalk will provide for safe bicycle and pedestrian that will connect Route 6 and Race Point Road to Conwell Street. Race Point Road ails and recreational spaces within the National Seashore area. There are proposed oute 6 in this area. The majority of the existing roadbed will be reused with areas of set existing alignments to minimize construction costs and impacts. Work includes es and new sidewalk into existing driveways, installing ADA compliant fixtures and ewalk, narrowing vehicular travel lane width, landscape features, pavement

WORK TO BE DONE:

controls/signing for construction operations.

WORK TO BE I	ONE:						
Force Account:		Advertised Contract:	Other:	Engineering	Bid	Services	and
			_	Contractor Co	nstructi	on Costs	

Estimated Cost (Please attach estimate and list funding source(s)): \$ 745,140.

These funds will pay 100% of Local Road Project costs to the limit of this assignment

CERTIFICATION

markings, minor drainage alternations, traffic calming features, and the provision of safety

The design, engineering, construction, and future performance of the project, including maintenance, is the responsibility of the Municipality. The proposed work will conform to recognized engineering and construction methods. I/We herby certify under penalty of perjury the following: that the project is on a public way, and any necessary takings have been made; that all materials will comply with approved established specifications; that all weights and quantities will be accurate; that equipment rental rates are those established by MassDOT Highway or the advertised low bid; that all documentation will be checked for accuracy, and will be endorsed in accordance with municipal procedures for accountability.

Reviewed by:	Signed:
Signed:	
State Aid Engineer Date	Highway Official's Title Date
Road Classification Verified:	
Approved for _\$ @ 100%	Accounting Official's Title Date
District Highway Director Date	Date Duly Authorized Municipal Officials

Project Cost Estimate

August 31, 2020

EPG Construction Estimate (includes Police Detail & 10% Contingency):	\$629,000
EPG Bid & Construction Phase Services:	\$48,400
10% Contingency:	\$67,740
Total Estimate:	\$745,140

TOWN OF PROVINCETOWN CONWELL STREET





March 7, 2016



A partnership for engineering solutions.

www.envpartners.com

Project Location







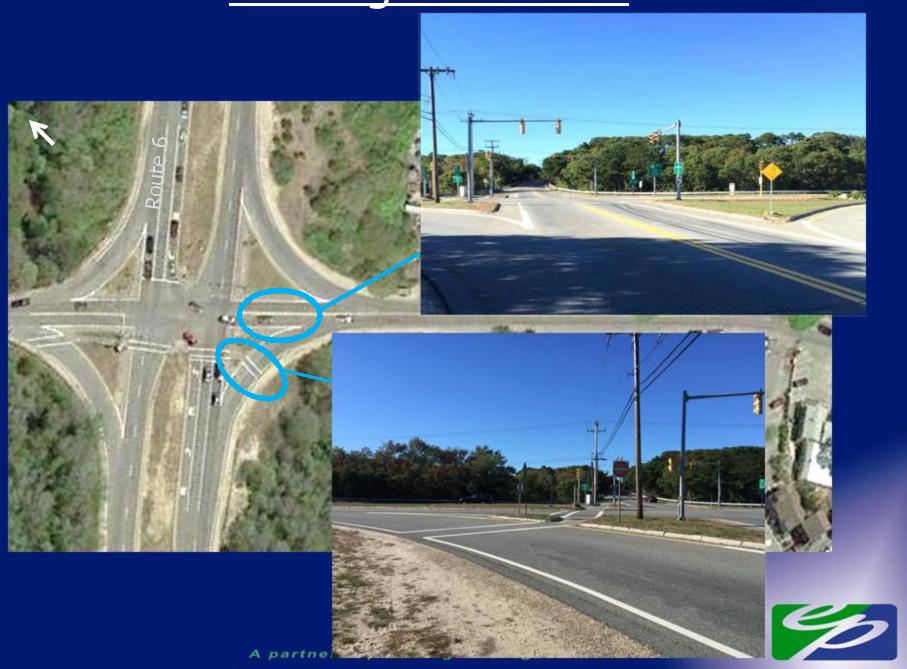


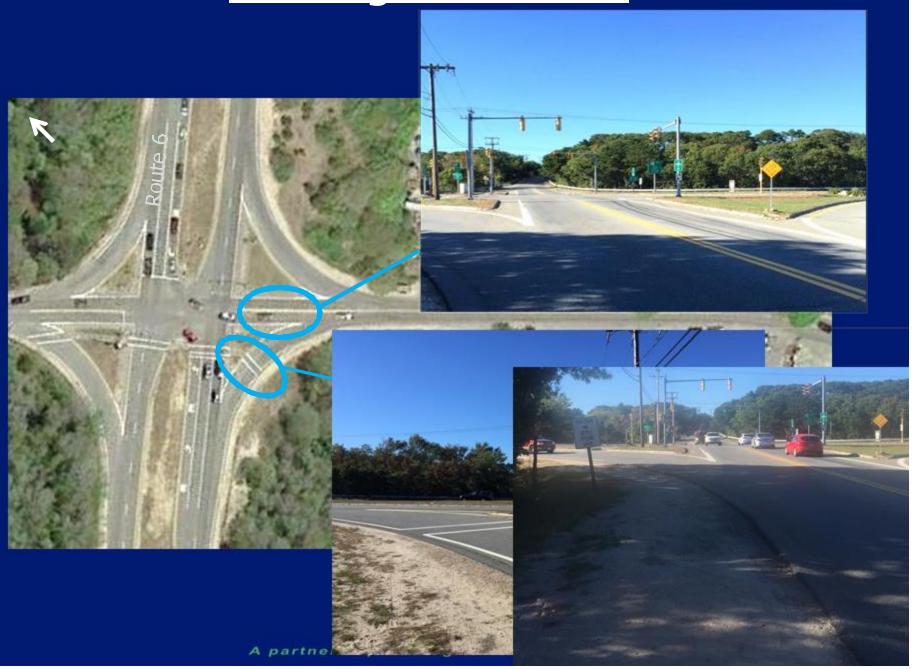






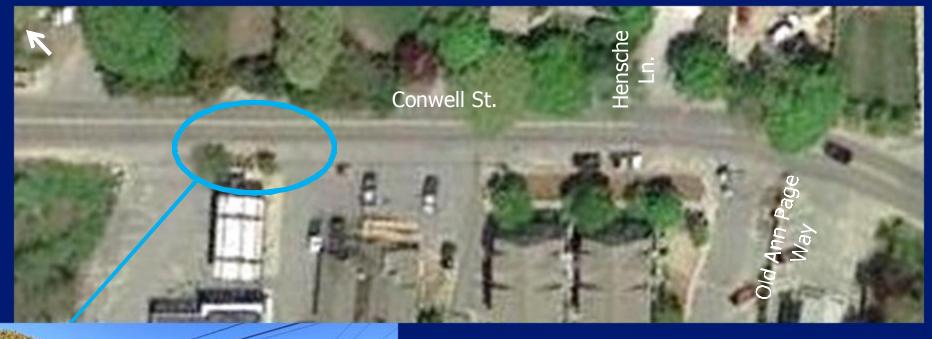












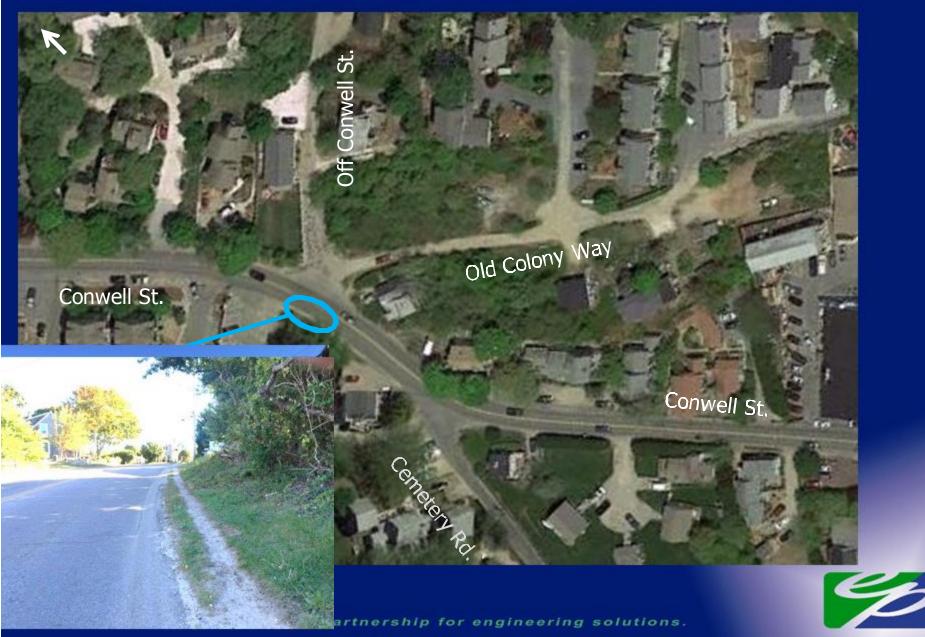








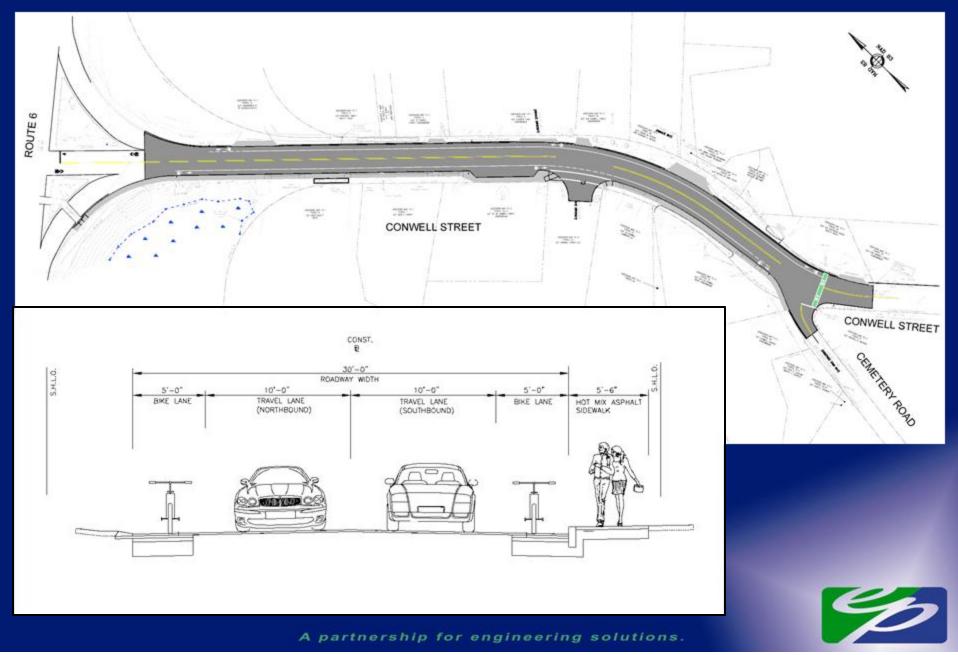


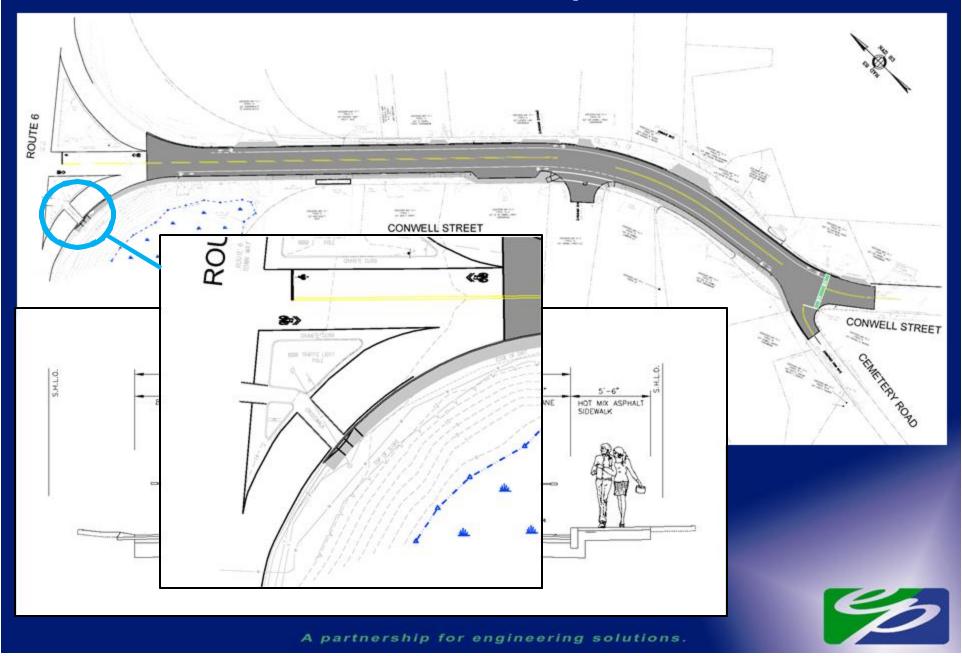


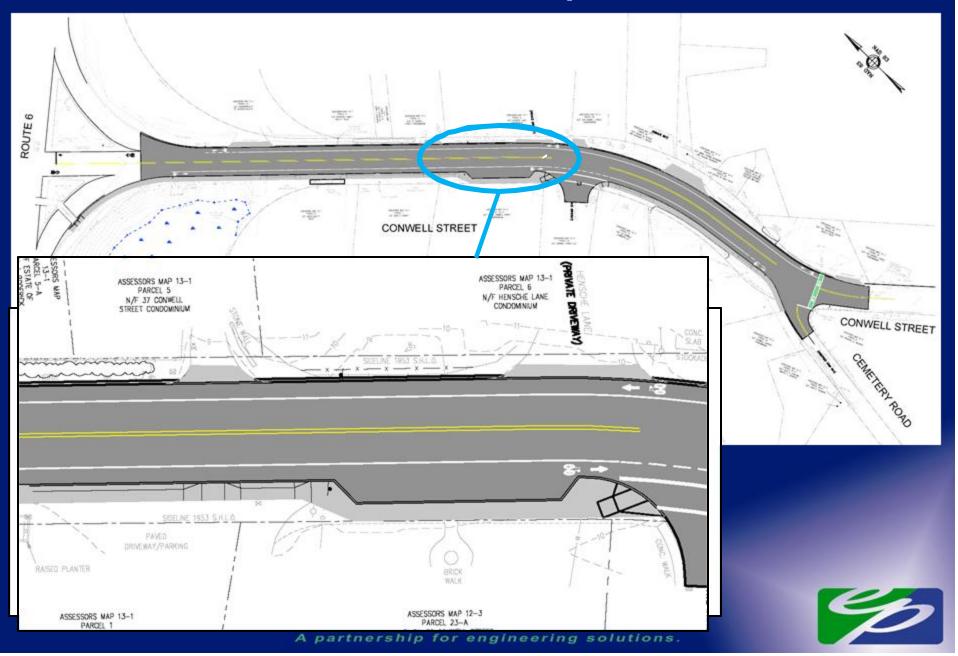


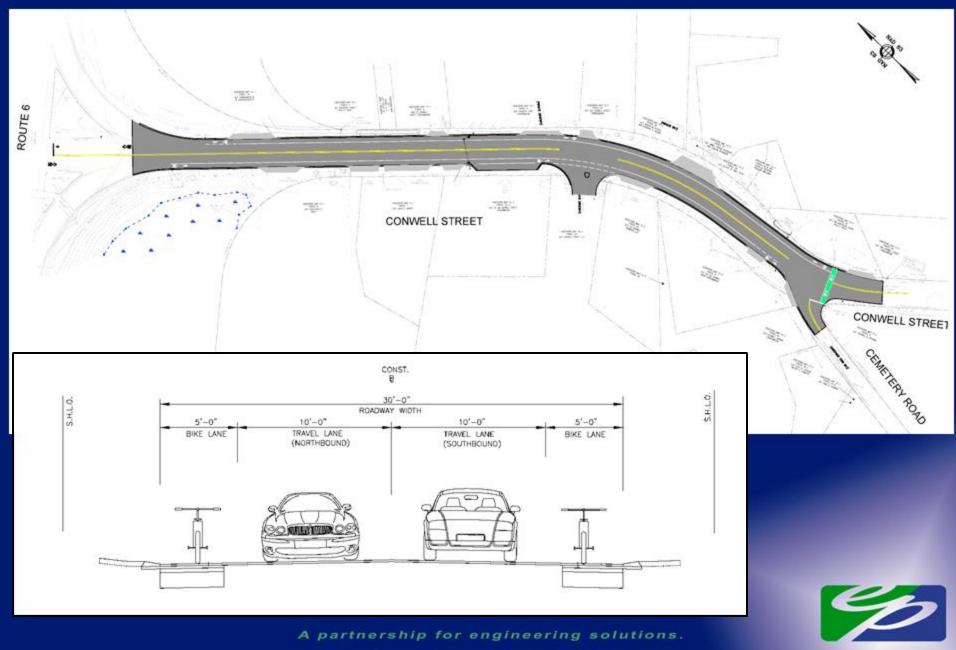


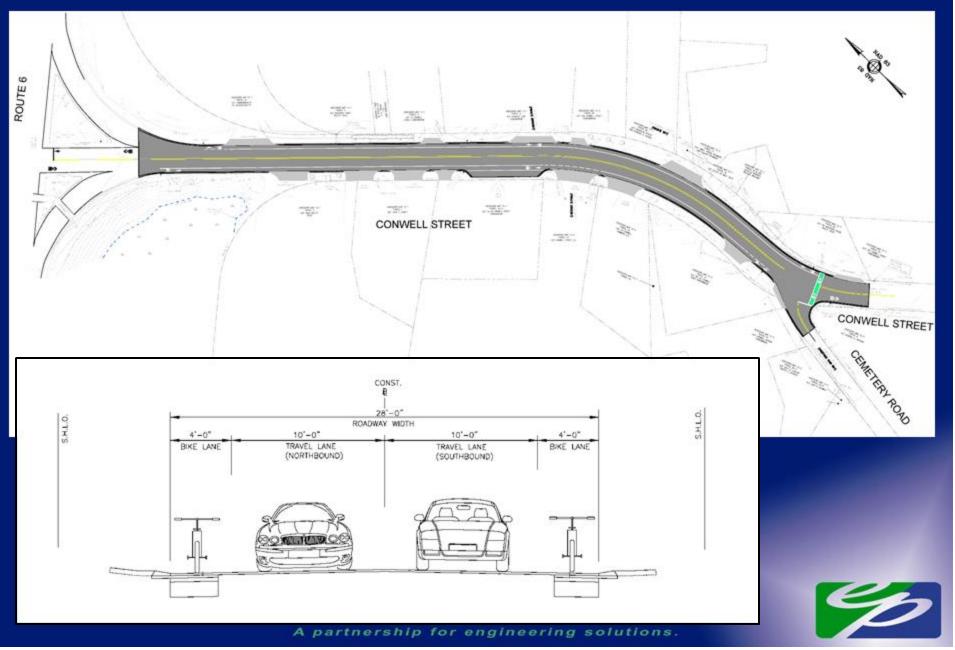


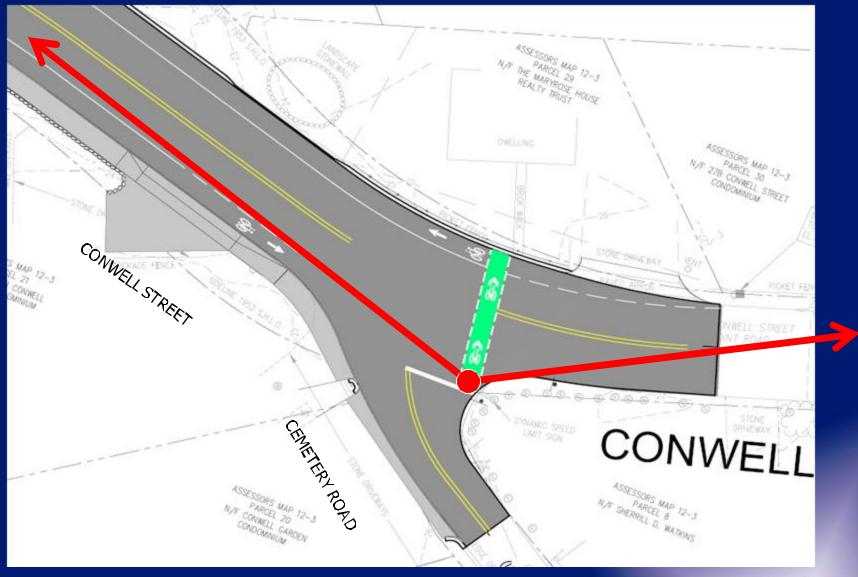




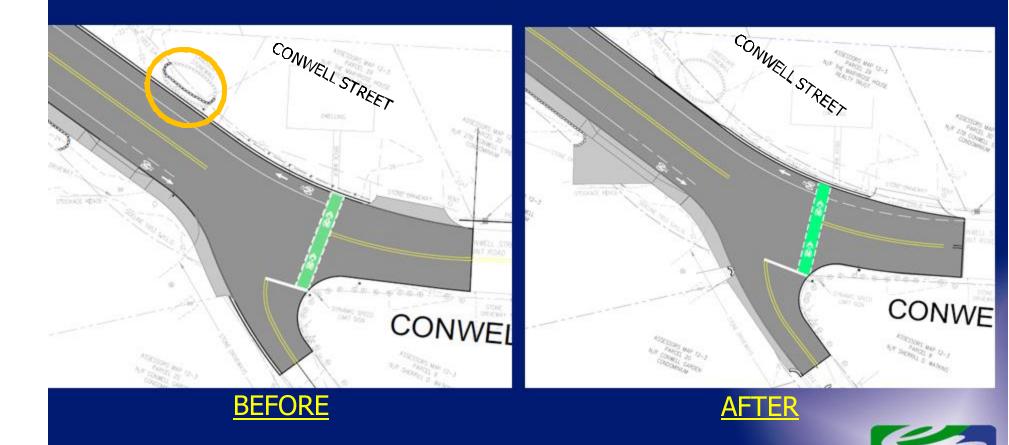
















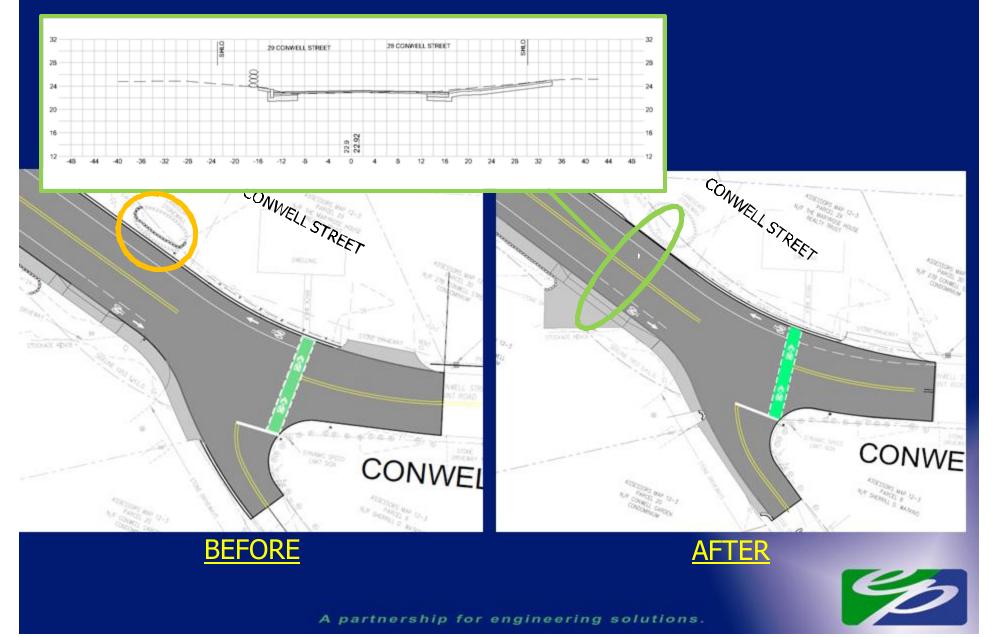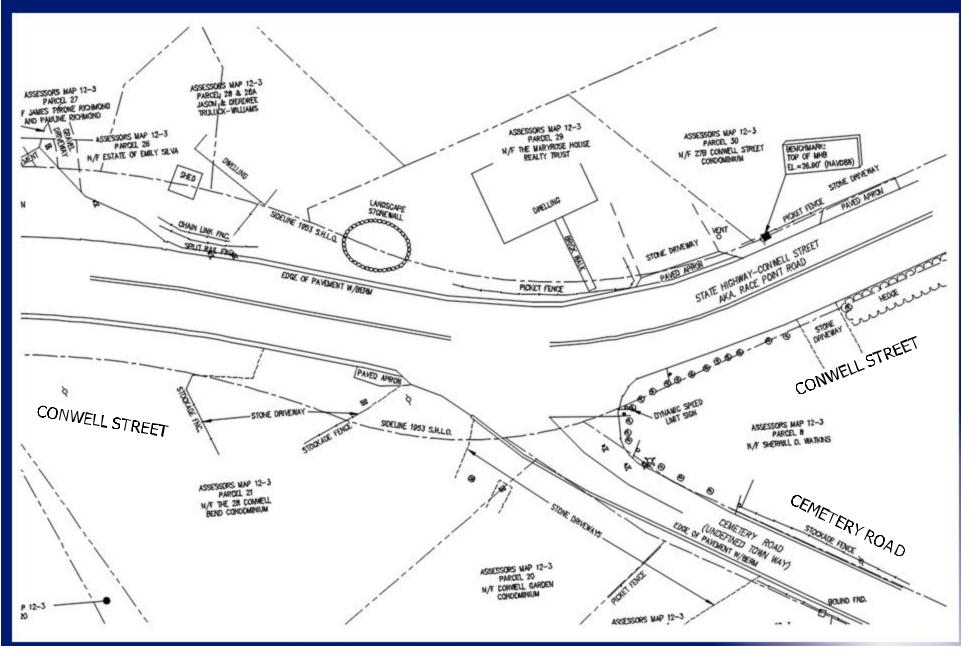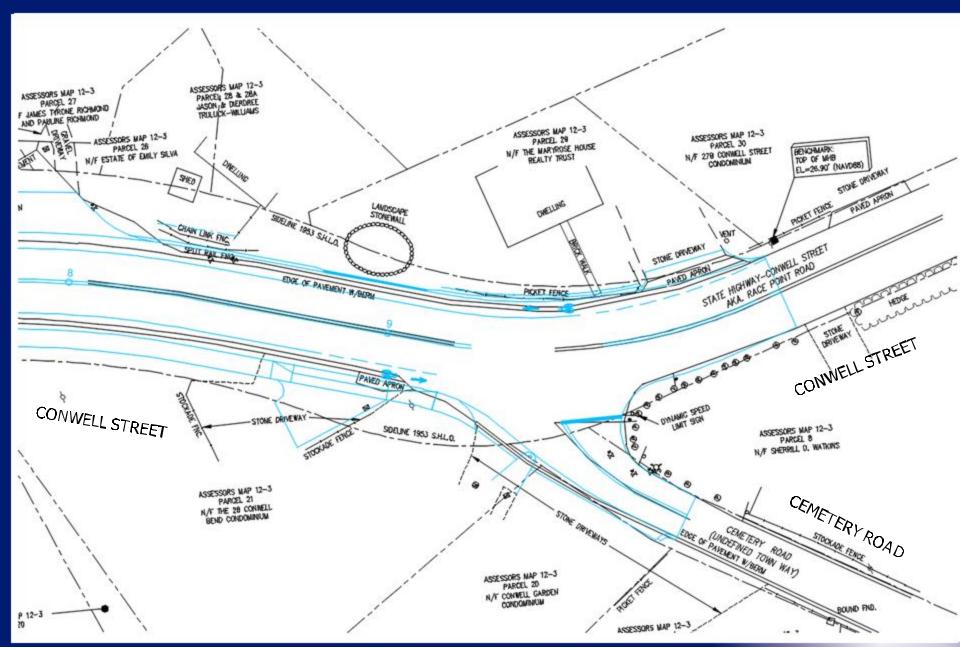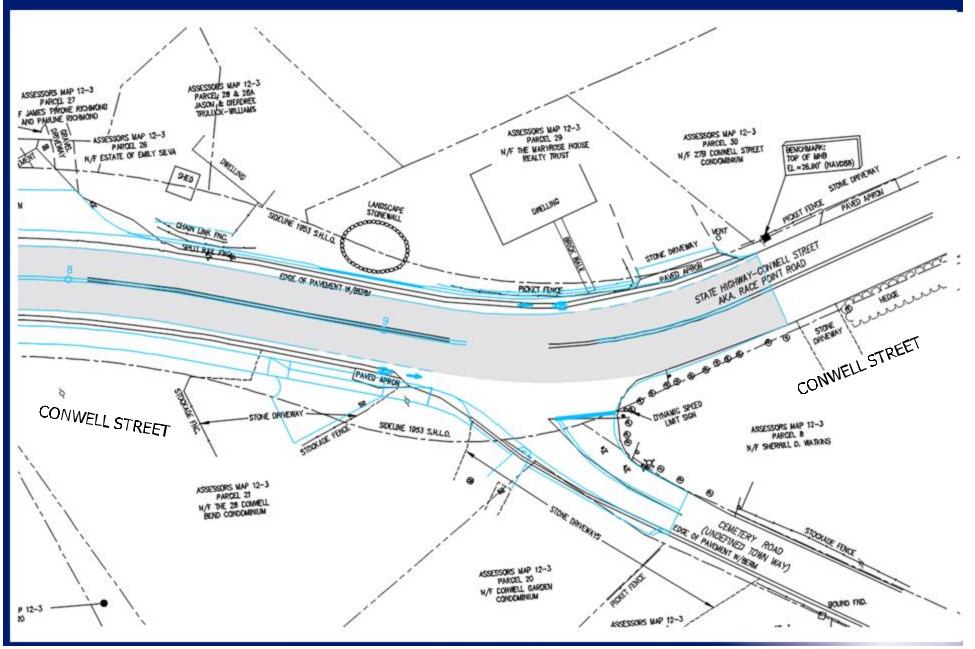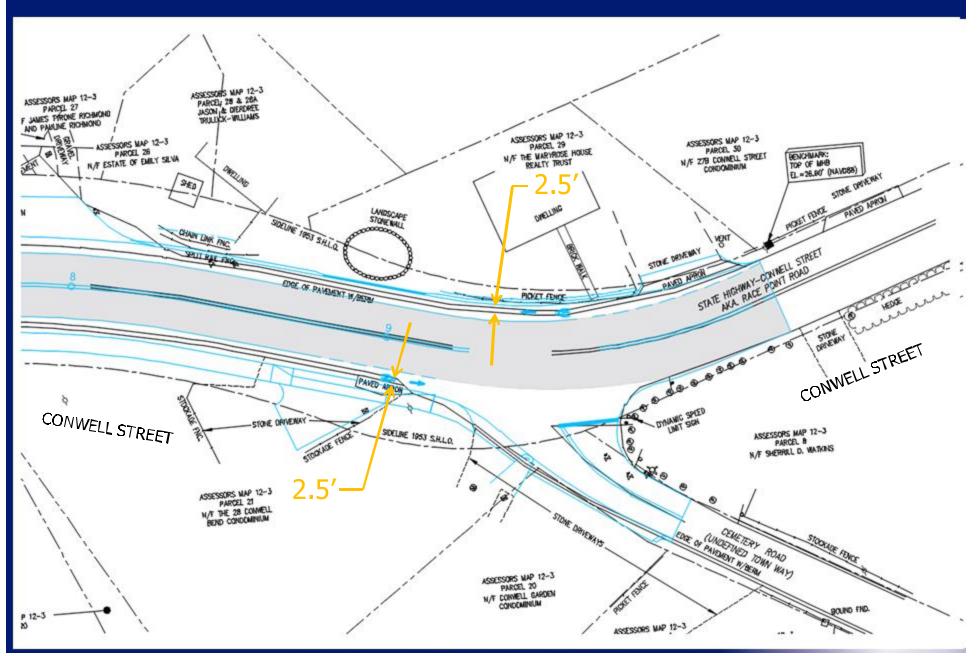
A partnership for engineering solutions.

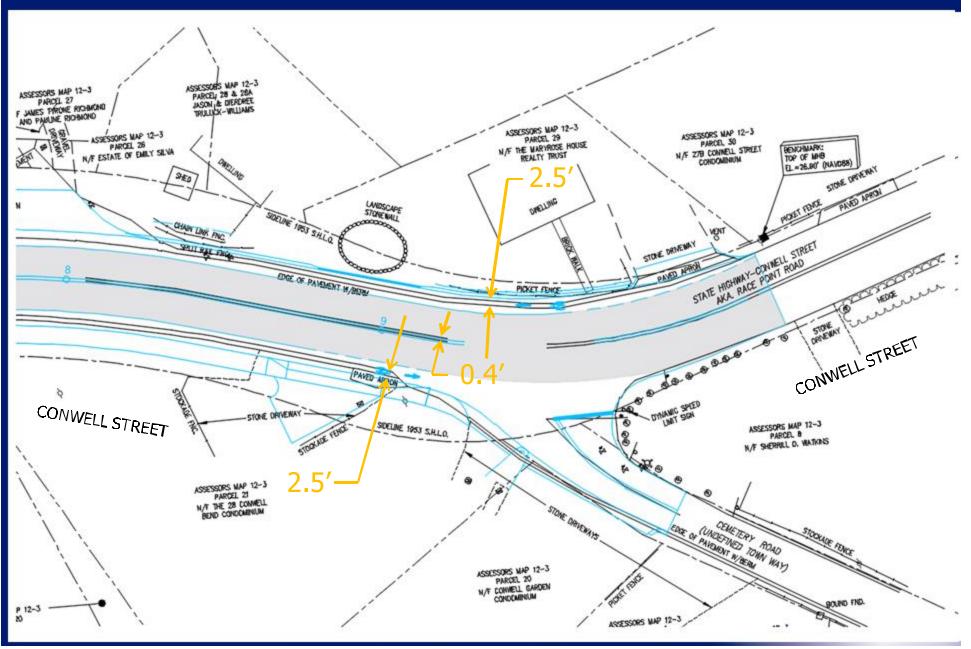














Typical Sections

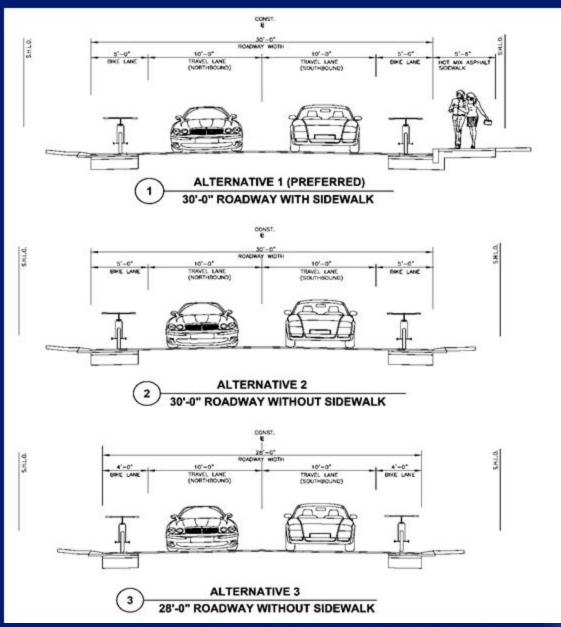




Typical Sections

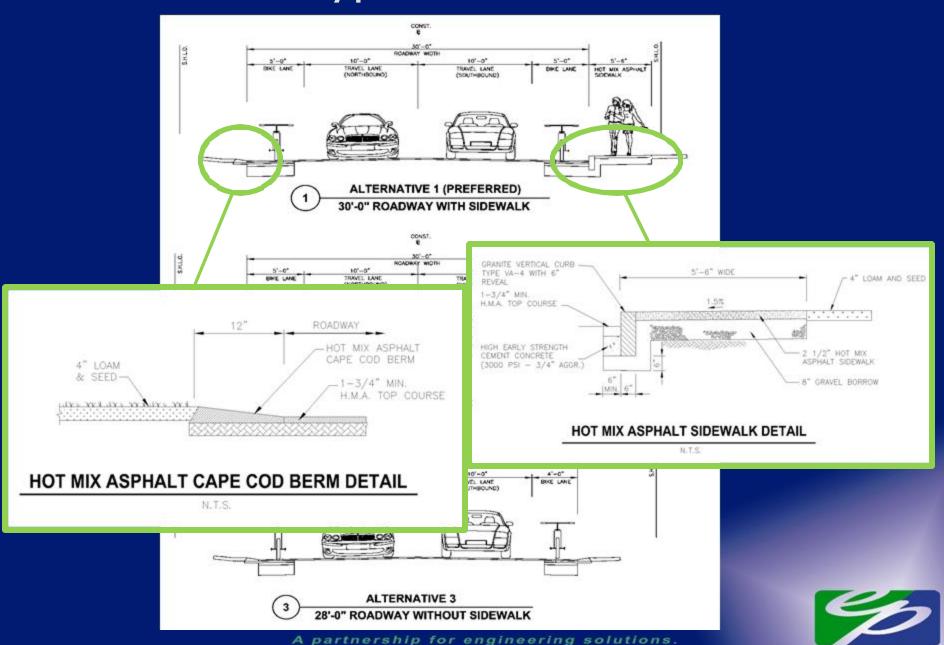


Preferred Typical Sections

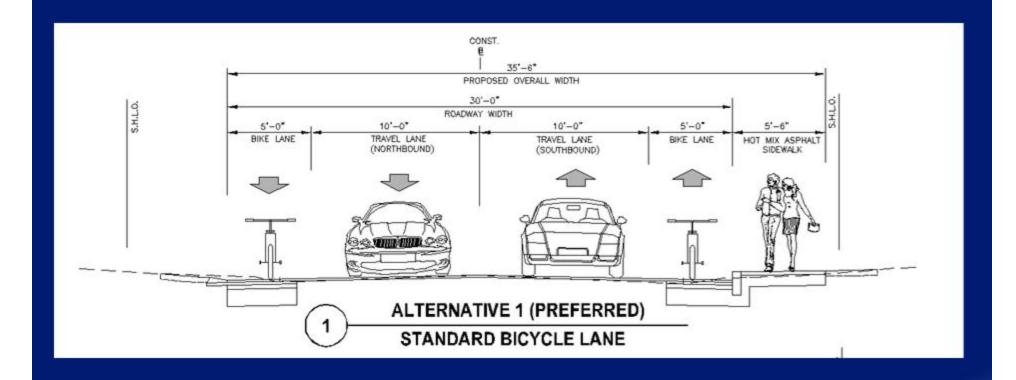




Additional Typical Sections Considered

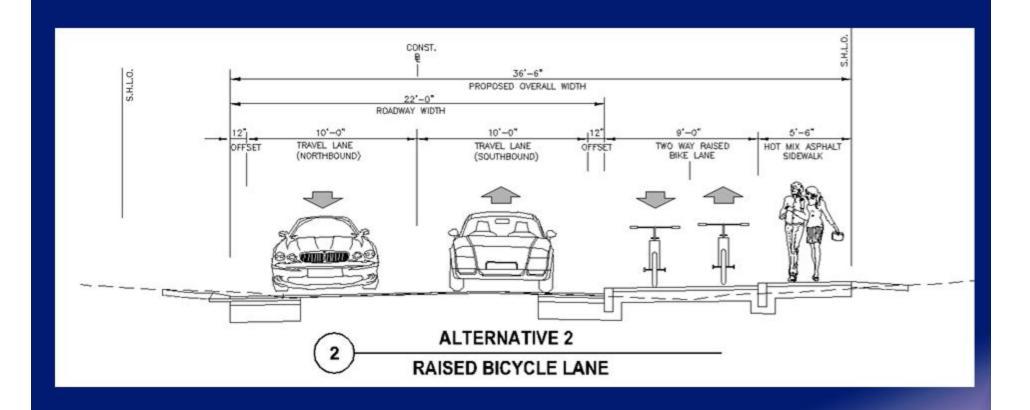





Additional Typical Sections Considered

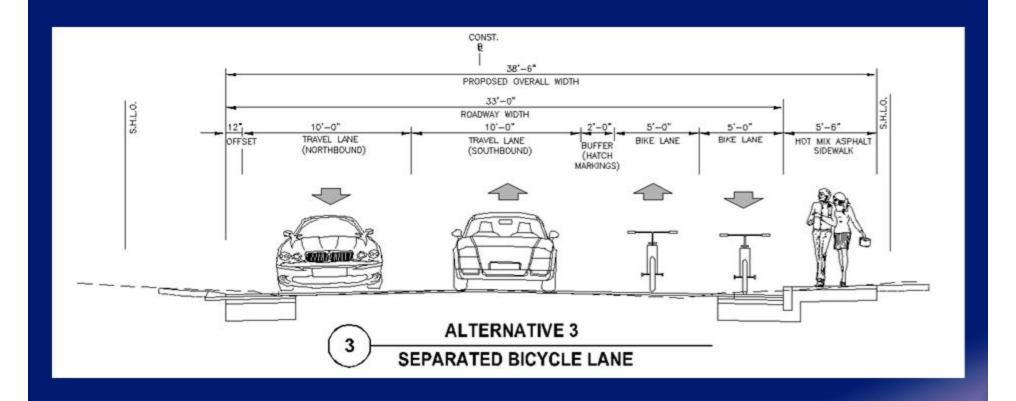



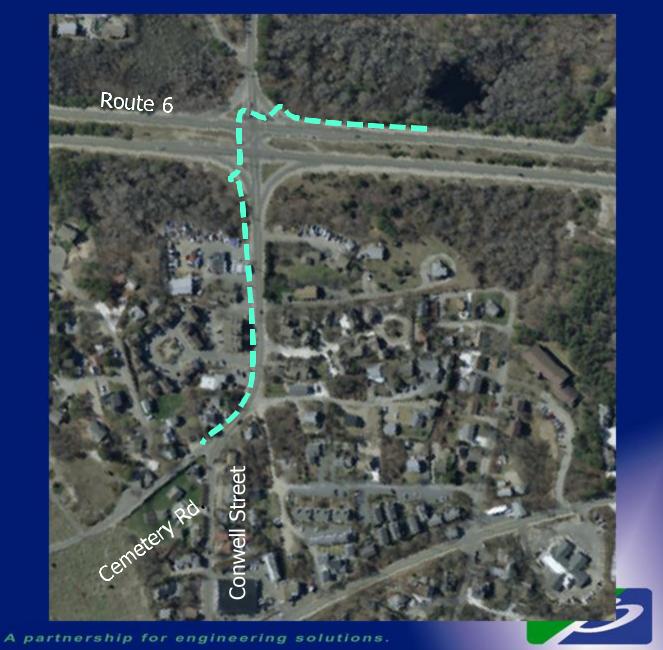

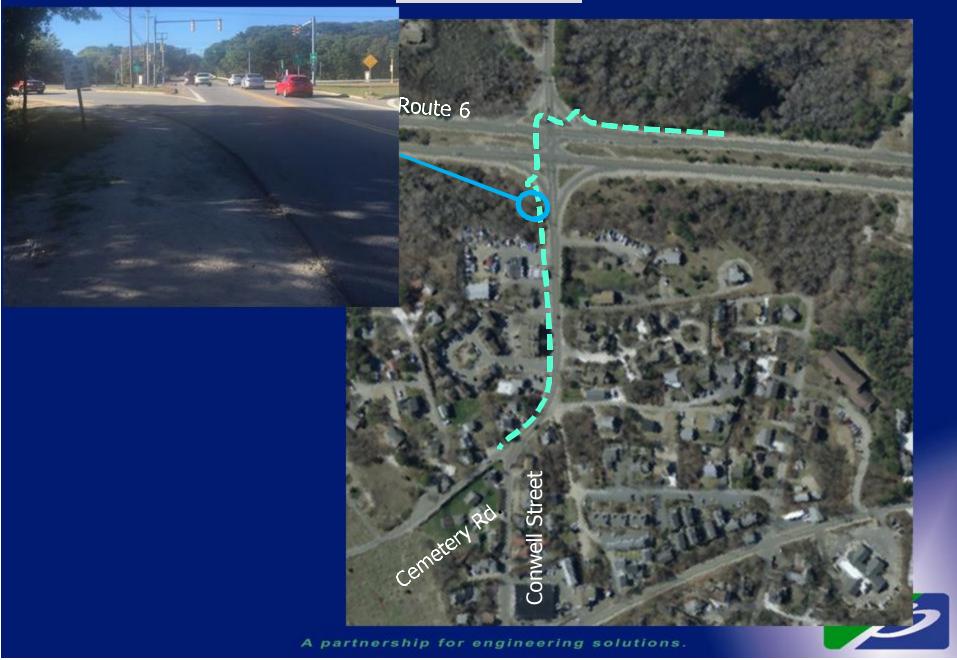





Thank you!



James D. Fitzgerald, P.E., LEED AP jdf@envpartners.com 617-657-0256

A partnership for engineering solutions.



(Provincetown DPW Letterhead)

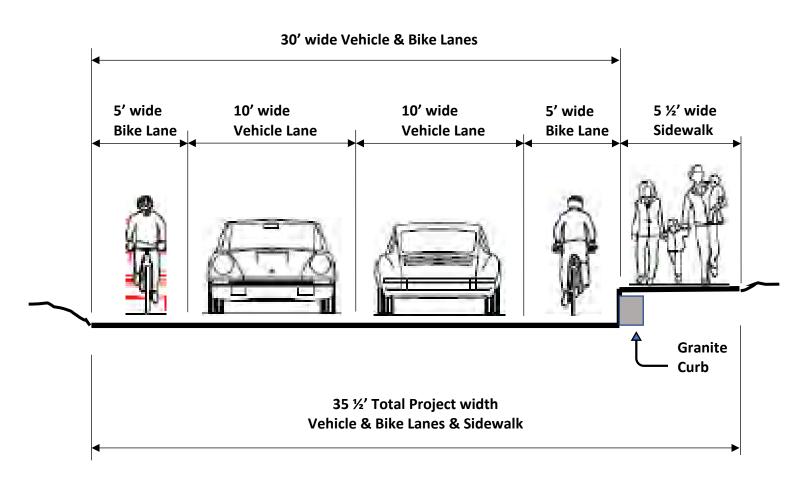
As an ongoing effort to inform the public, this informational notice is an update to the road improvement project along Conwell Street, between Route 6 and Cemetery Avenue.

Provincetown received a Road Work Permit from the Mass Department of Transportation to move forward with this project. The Town is now reviewing options for and working towards securing construction funding. Although a schedule has not been set we anticipate work to begin in the Spring/Fall of 2019

This project will include:

- New paved road surface
- Storm water improvements
- New bike lanes along both sides of the road
- New curb and sidewalk on the West side of the road
- New painted lines and markings
- New roadway signs

Following is a sketch of the roadway design approved by MassDOT:




Sketch of Conwell Street Road Project

The final approved project design, which includes two bike lanes and one sidewalk, is the same as the "Preferred Option" that was originally proposed, with minor changes to accommodate abutters' requests.

History of Public Notifications, Hearings, Meetings & Workshops:


- May 14, 2015 Design Services IFB published in the Banner.
- May 21, 2015 Design Services IFB published in the Banner.
- May 21, 2015 Public Bid Opening (published on Facebook & in IFB notices).
- June 22, 2015 Public Hearing with BOS for Contract Authorization (advertised prior week).
- June 24, 2015 Contract Award published in Central Register.
- August 24, 2015 Public Hearing with BOS to authorize amended contract (advertised prior week).
- November 9, 2015 Public Hearing with BOS for Preliminary Design proposals and preferred design direction (advertised prior week).
- November 10, 2015 December 20, 2015 Internet & Paper Public Survey to indicate support or opposition to project: 67 responses.
- November 23, 2015 Public Workshop No. 1 notices mailed to abutters.
- December 10, 2015 Public Workshop No. 1 held and Public Records Request filed.
- February 9, 2016 Public Workshop No. 2 notices mailed to abutters.
- February 15, 2016 Public Workshop No. 2 reminder notices mailed to abutters.
- March 7, 2016 Public Workshop No. 2 held @ Town Hall. Design reflected changes from Workshop No. 1.
- March 28, 2016 Outer Cape Bicycle and Pedestrian Master Plan project update.
- April 26, 2016 Public Hearing with Conservation Commission with project update.
- Project Notice of Intent filed with MDEP, NHESP information submitted to MassDOT, Certified Abutter Notifications sent.
- August 2, 2016 Conservation Commission Meeting for Notice of Intent.

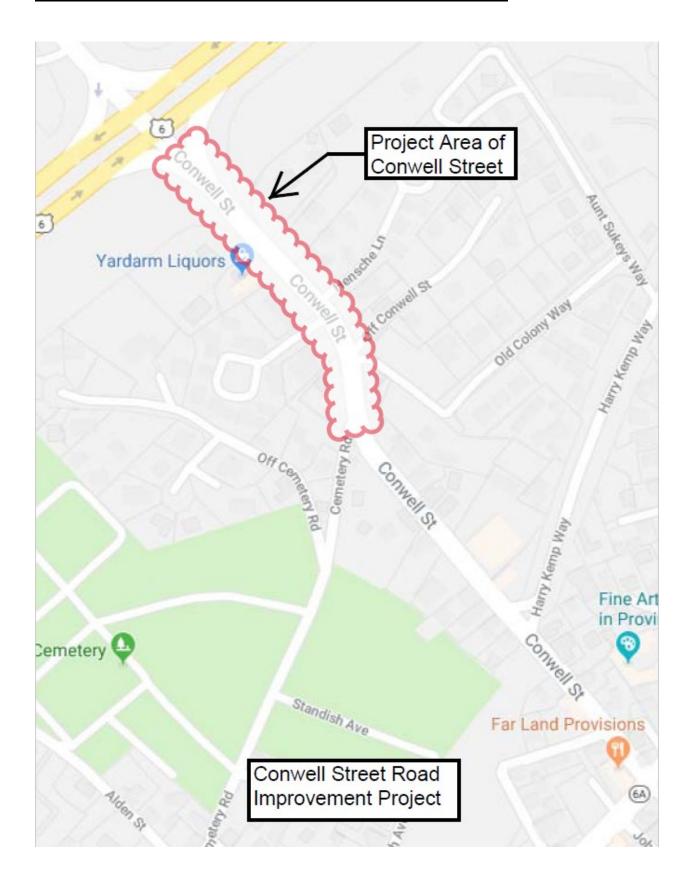Following is a Site Plan showing the involved portion of Conwell Street:



Page 3 of 4

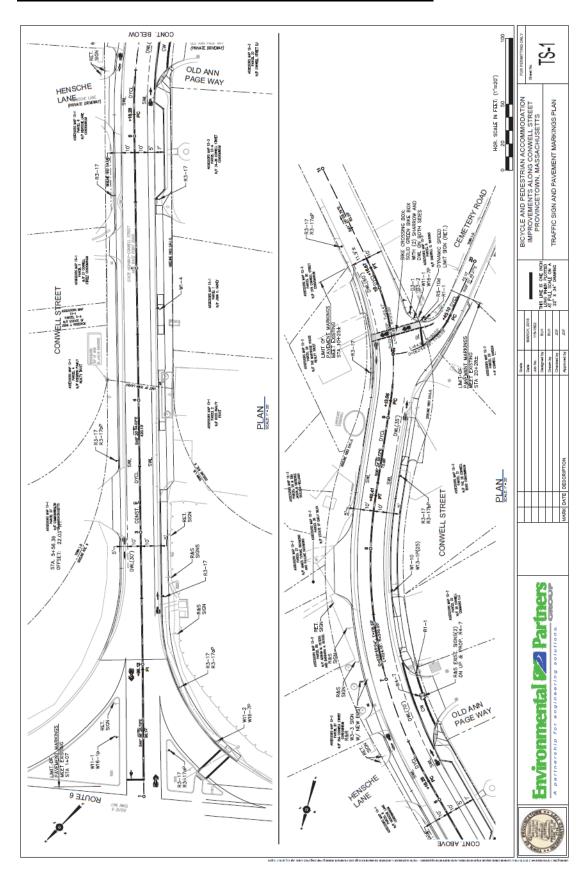Following is the Traffic Sign & Marking Plan for Conwell Street:



Page 4 of 4

APRIL, 2018


LIST OF DRAWINGS

SHEET NO.	DESCRIPTION
	TITLE SHEET
G-1	LEGENDS, GENERAL NOTES AND KEY PLAN
C-1	CONSTRUCTION PLAN AND PROFILE (STA. 1+00 TO STA. 6+50)
C-2	CONSTRUCTION AND PROFILE (STA. 6+5- TO STA. 11+00)
C-3	CURB TIE PLAN
C-4 - C-7	CONSTRUCTION DETAILS
TS-1	TRAFFIC SIGNS AND PAVEMENT MARKINGS PLAN
TS-2	TRAFFIC SIGN SUMMARY AND PAVEMENT MARKING DETAILS
TMP-1	TRAFFIC MANAGEMENT PLAN
CX-1 - CX-8	CROSS SECTIONS

DESIGN DESIGNATION

	CONWELL ST.
DESIGN SPEED	25 MPH
ADT* (2013)	7,495
ADT (2023)	7,770
K	8.9%
D	59% NB
T (PEAK HOUR)	N/A
T (AVERAGE DAY)	N/A
DHV	632
DDHV	373
UNCTIONAL CLASSIFICATION	URBAN MINOR ARTERIAL

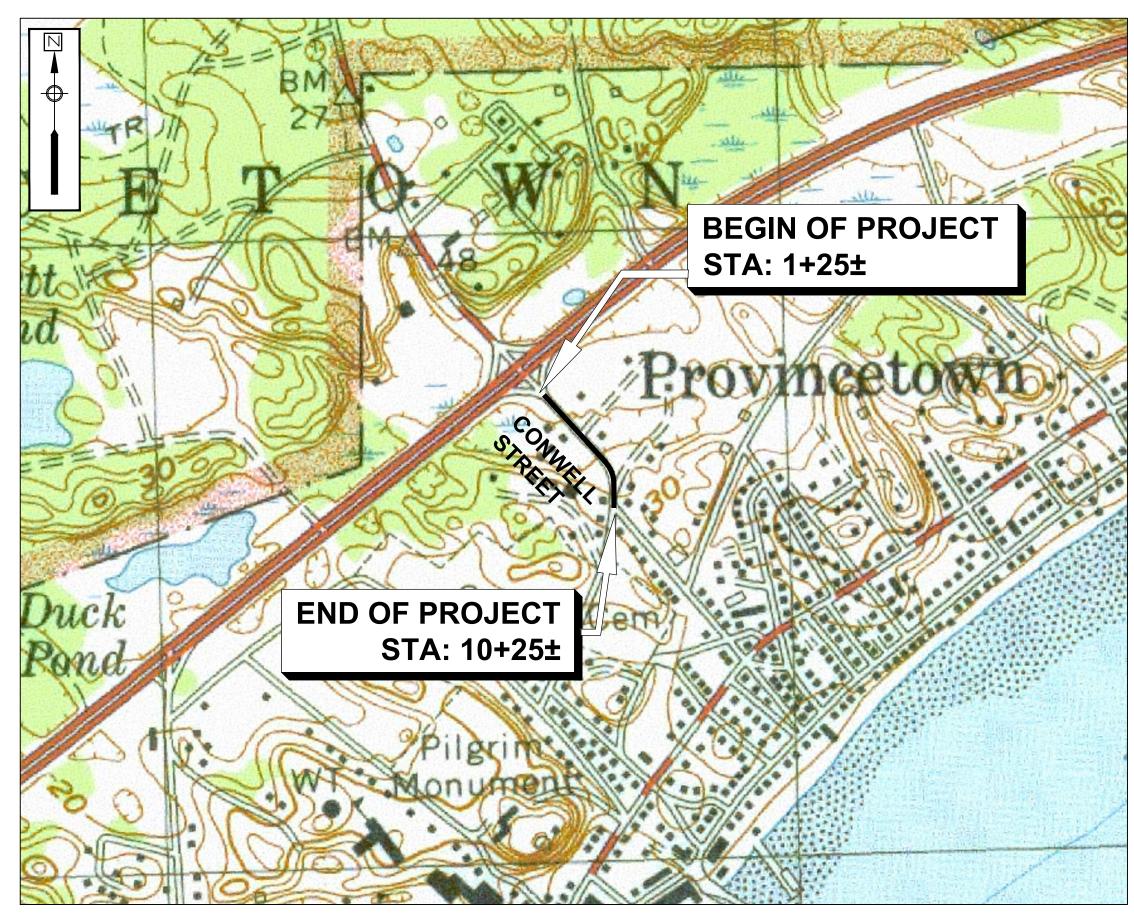* RESOURCE: TRAFFIC VOLUME TAKEN FROM 2016 TRAFFIC COUNTING REPORT FOR CAPE COD MASSACHUSETTS BY CAPE COD COMMISSION



VICINITY MAP

1"= 500'





PREPARED FOR:

TOWN OF PROVINCETOWN
DEPARTMENT OF PUBLIC WORKS
RICHARD J. WALDO, P.E., PUBLIC WORK DIRECTOR
ERIC L. LARSEN, DEPUTY DIRECTOR
2 MAYFLOWER STREET
PROVINCETOWN, MA 02657
P: 508-487-7060

PREPARED BY:

ENVIRONMENTAL PARTNERS GROUP, INC. 1900 CROWN COLONY DRIVE, SUITE 402 QUINCY, MA 02169 P: 617-657-0200 F: 617-657-0201



STONEWALLS, FENCES, ETC. WITHIN THE CONSTRUCTION AREA UNLESS THEY ARE NOTED TO BE REMOVED. CONTRACTOR SHALL REMOVE AND REPLACE, OR REPAIR, ALL CURBS, SIDE WALKS, PAVEMENT AND OTHER

ANY TRAFFIC SIGNAL EQUIPMENT (LIGHTS, CONDUITS, LOOP DETECTORS) DISTURBED SHALL BE REPAIRED OR REPLACED BY THE CONTRACTOR AS DIRECTED BY THE TOWN AT THE CONTRACTOR'S EXPENSE.

THE CONTRACTOR SHALL INSTALL AND MAINTAIN TRAFFIC CONTROL DEVICES AS NECESSARY AND IN ACCORDANCE WITH THE MANUAL ON UNIFORM TRAFFIC CONTROL DEVICES.

THE CONTRACTOR SHALL BE REQUIRED TO FURNISH AND MAINTAIN A TELEPHONE NUMBER WHERE THE CONTRACTOR CAN BE REACHED 24 HOURS A DAY, 7 DAYS A WEEK.

THE LOCATION AND LIMITS OF ALL ON-SITE WORK AND STORAGE AREAS SHALL BE REVIEWED/COORDINATED WITH, AND ACCEPTABLE TO THE TOWN. THE CONTRACTOR SHALL LIMIT HIS ACTIVITIES TO THESE AREA.

THE CONTRACTOR SHALL HANDLE GROUNDWATER, WHERE ENCOUNTERED, IN AN APPROVED MANNER. DURING ANY DEWATERING. THE CONTRACTOR SHALL USE TEMPORARY STONE AROUND THE SUCTION AND DISCHARGE ENDS TO MINIMIZE TRANSPORT OF TRENCH MATERIALS. THE DISCHARGED WATER SHALL PASS THROUGH FILTER FABRIC, SILT BAGS, FRAC TANKS OR A COMBINATION OF ALL.

PROVIDE TEMPORARY BERMS AND SWALES TO DIVERT SURFACE WATER AWAY FROM THE AREAS THAT WILL BE EXPOSED BY CONSTRUCTION ACTIVITY TO MINIMIZE THE AMOUNT OF SURFACE WATER COMING INTO CONTACT WITH EXPOSED SOILS. PROVIDE STABLE OUTLETS FOR THESE DEVICES, AND LINE OR VEGETATE THESE DIVERSIONS TO PROVIDE FOR THEIR STABILITY DURING CONSTRUCTION.

WHEN EARTHWORK CONSTRUCTION ACTIVITY IN AN AREA IS COMPLETE, IMMEDIATELY STABILIZE THE AREA WITH A SUITABLE SURFACE AS DESCRIBED HEREIN.

EARTH WORK NOTES:

- DEWATERING PUMPING SYSTEM DISCHARGE TO INCLUDE ENERGY DISSIPATION TO PREVENT SCOUR.
- AGGREGATE MATERIALS (GRAVEL, LOAM, STONE) SHALL NOT BE STOCKPILED ON-SITE. MATERIALS SHALL BE STORED OFF-SITE OR DELIVERED DAILY AS NEEDED.
 - TEMPORARY DEWATERING SEDIMENTATION BASINS, IF REQUIRED, WILL BE CHECKED AFTER EACH SIGNIFICANT RAINFALL AND CLEANED AS NEEDED TO RETAIN STORAGE CAPACITY.
 - TEMPORARY DRAINAGE SWALES. IF REQUIRED. WILL BE CHECKED DAILY AND REPAIRED WHEN NECESSARY.
- INSTALL SEDIMENTATION FILTER SOCK AND SILT SACK AT EXISTING AND PROPOSED CATCH BASINS PRIOR TO COMMENCEMENT OF THE EARTHWORK OPERATIONS. INSPECT EROSION CONTROLS IMMEDIATELY AFTER EACH STORM AND REMOVE ACCUMULATED SEDIMENT AS REQUIRED. REPLACE DAMAGED EROSION CONTROLS AS REQUIRED.
- TURBIDITY, SEDIMENT AND EROSION CONTROL MATERIALS SHALL BE INSPECTED BY THE PROVINCETOWN CONSERVATION AGENT FOLLOWING INSTALLATION AND PRIOR TO ANY FURTHER CONSTRUCTION ACTIVITIES. CONTRACTOR SHALL NOTIFY THE AGENT THAT MATERIALS ARE READY FOR INSPECTION.
- SPILL KITS SHALL BE MAINTAINED ON-SITE AT ALL TIMES.
- SECONDARY CONTAINMENT SHALL BE PROVIDED FOR ALL DIESEL OR GASOLINE POWERED GENERATORS AND PUMPS.

DRAINAGE NOTES:

- NEW STORM DRAINS AND SERVICES SHALL BE INSTALLED AT THE MINIMUM DEPTH FROM FINISH GRADE TO TOP OF PIPE AS SHOWN ON THE DRAWINGS. WHERE NECESSARY. FINAL INVERT ELEVATIONS WILL BE CONFIRM BY THE CONTRACTOR IN THE FILED.
- ALL CATCH BASINS TO BE REMOVED AS SHOWN ON THE PLANS SHALL BE DISPOSED OF BY THE CONTRACTOR. THE CONTRACTOR SHALL COMPLY WITH MASSDOT STANDARD SPECIFICATIONS WITH RESPECT TO BACKFILLING UTILITY TRENCHES AT THE REMOVED DRAINAGE STRUCTURE AREAS.
- ALL PROPOSED DRAINAGE PIPES, TO REPLACE EXISTING PIPES, SHALL BE INSTALLED AT LEAST 1% SLOPE WHERE POSSIBLE, BUT NO FLATTER THAN 0.4% SLOPE.
- OPEN TRENCHES MUST BE BACK FILLED AT THE END OF THE WORKDAY OR COVERED WITH STEEL PLATES.

LEGEND

PROPOSED TRAFFIC **EXISTING** MASS HIGHWAY BOUND BROKEN WHITE LANE LINE — 6' CATCH BASIN SOLID WHITE LINE - 6" EXC. AS NOTED DOUBLE CATCH BASIN DCB SOLID YELLOW CENTER LINE — 6" EXC. AS NOTE CATCH BASIN CURB INLET BROKEN YELLOW CENTER LINE — 6" OUBLE YELLOW CENTER LINES - 2-6 TELEPHONE MANHOLE YELLOW DIAGONAL LINE -MANHOLE WHITE DIAGONAL LINE — WATER VALVE YELLOW GORE LINE — 1 HYDRANT WHITE GORE LINE — DOTTED WHITE LINE — 1'X3' LINE, 3' SPACE WATER METER PI ROSSWALK, 1' WHITE LINES — 8' OFFSET CW TOP LINE, 1' WHITE LINE 4' BEHIND CW (TYF POST

PROPERTY LINI

UTILITY POL

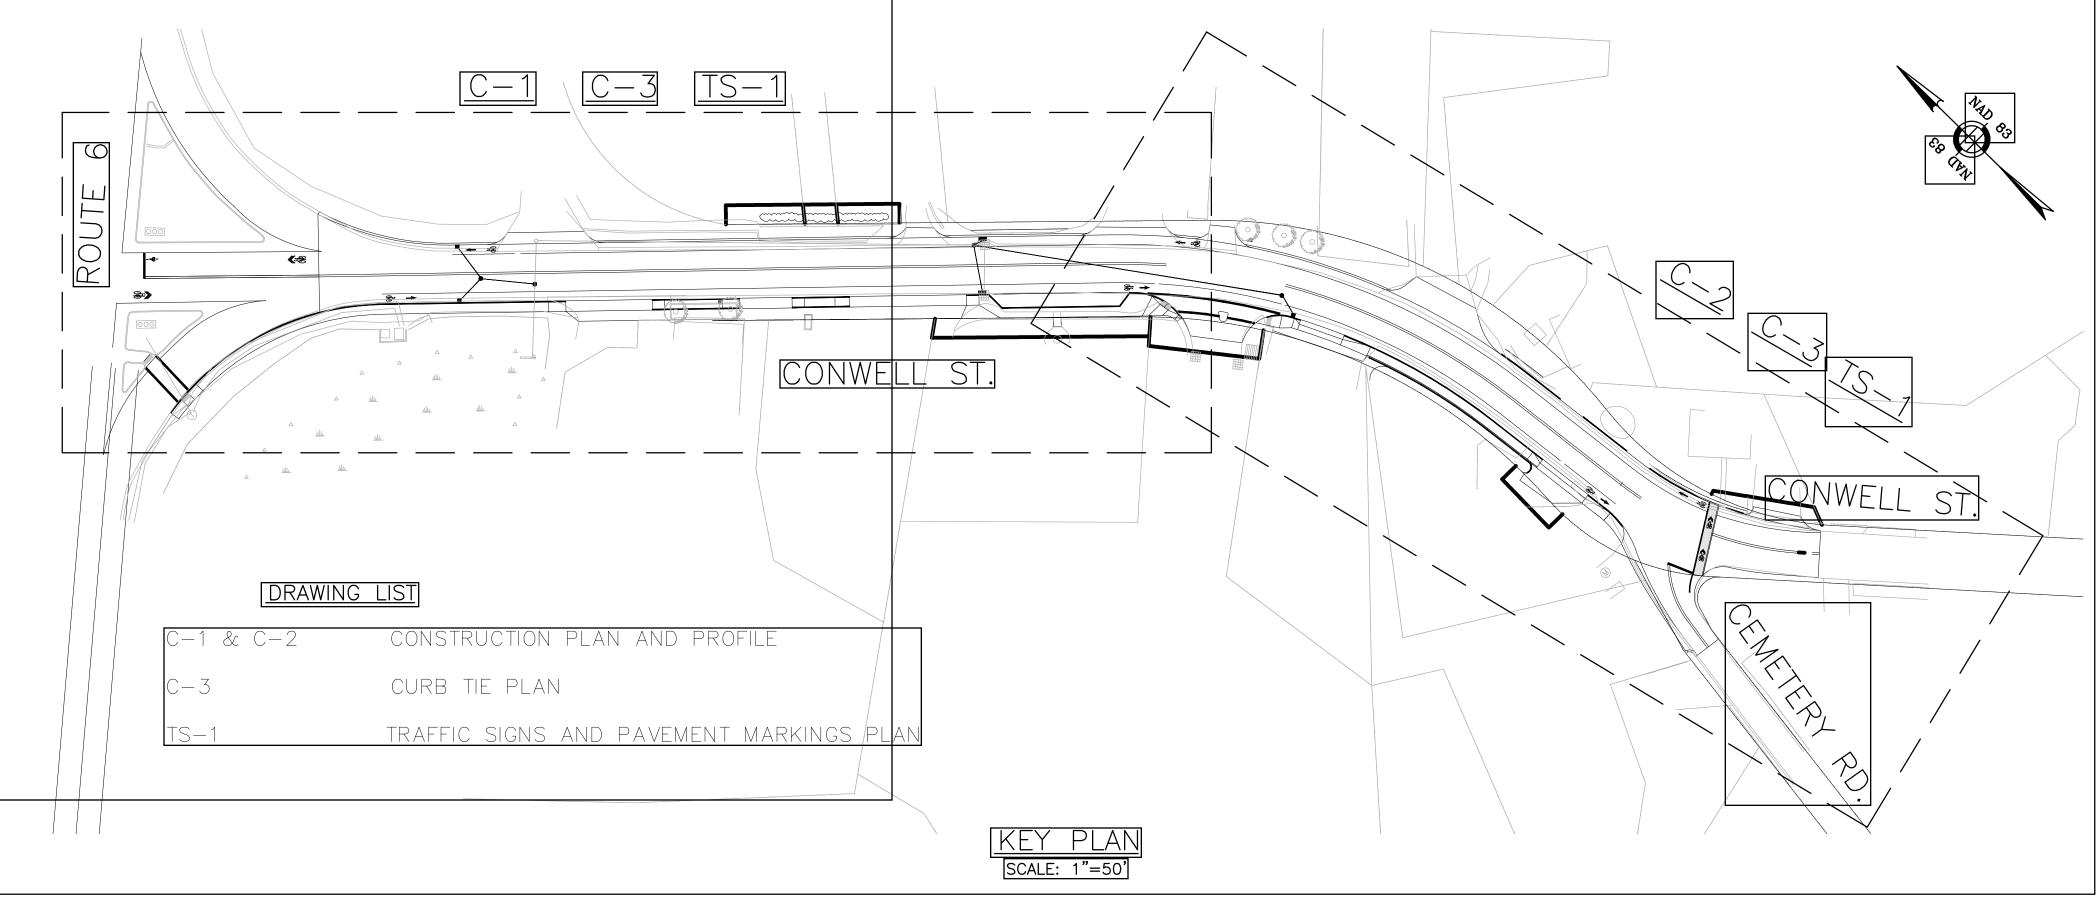
GUY WIRE

TREE

CONGO UR

DRAIN PIPE WATER LINE WETLAND FLAC

MAILBOX



WV

 \geq

Environmental Partners A partnership for engineering solutions.

			Scale	SEE ABOVE		F
			Date	MARCH, 2018		-
			Job No.	115-1502		
			Designed by	BLH	THIS LINE IS ONE INCH LONG WHEN PLOTTED	
			Drawn by	BLH	AT FULL SCALE ON A	
			Checked by	JDF	22" X 34" DRAWING	
MARK	DATE	DESCRIPTION	Approved by	JDF		

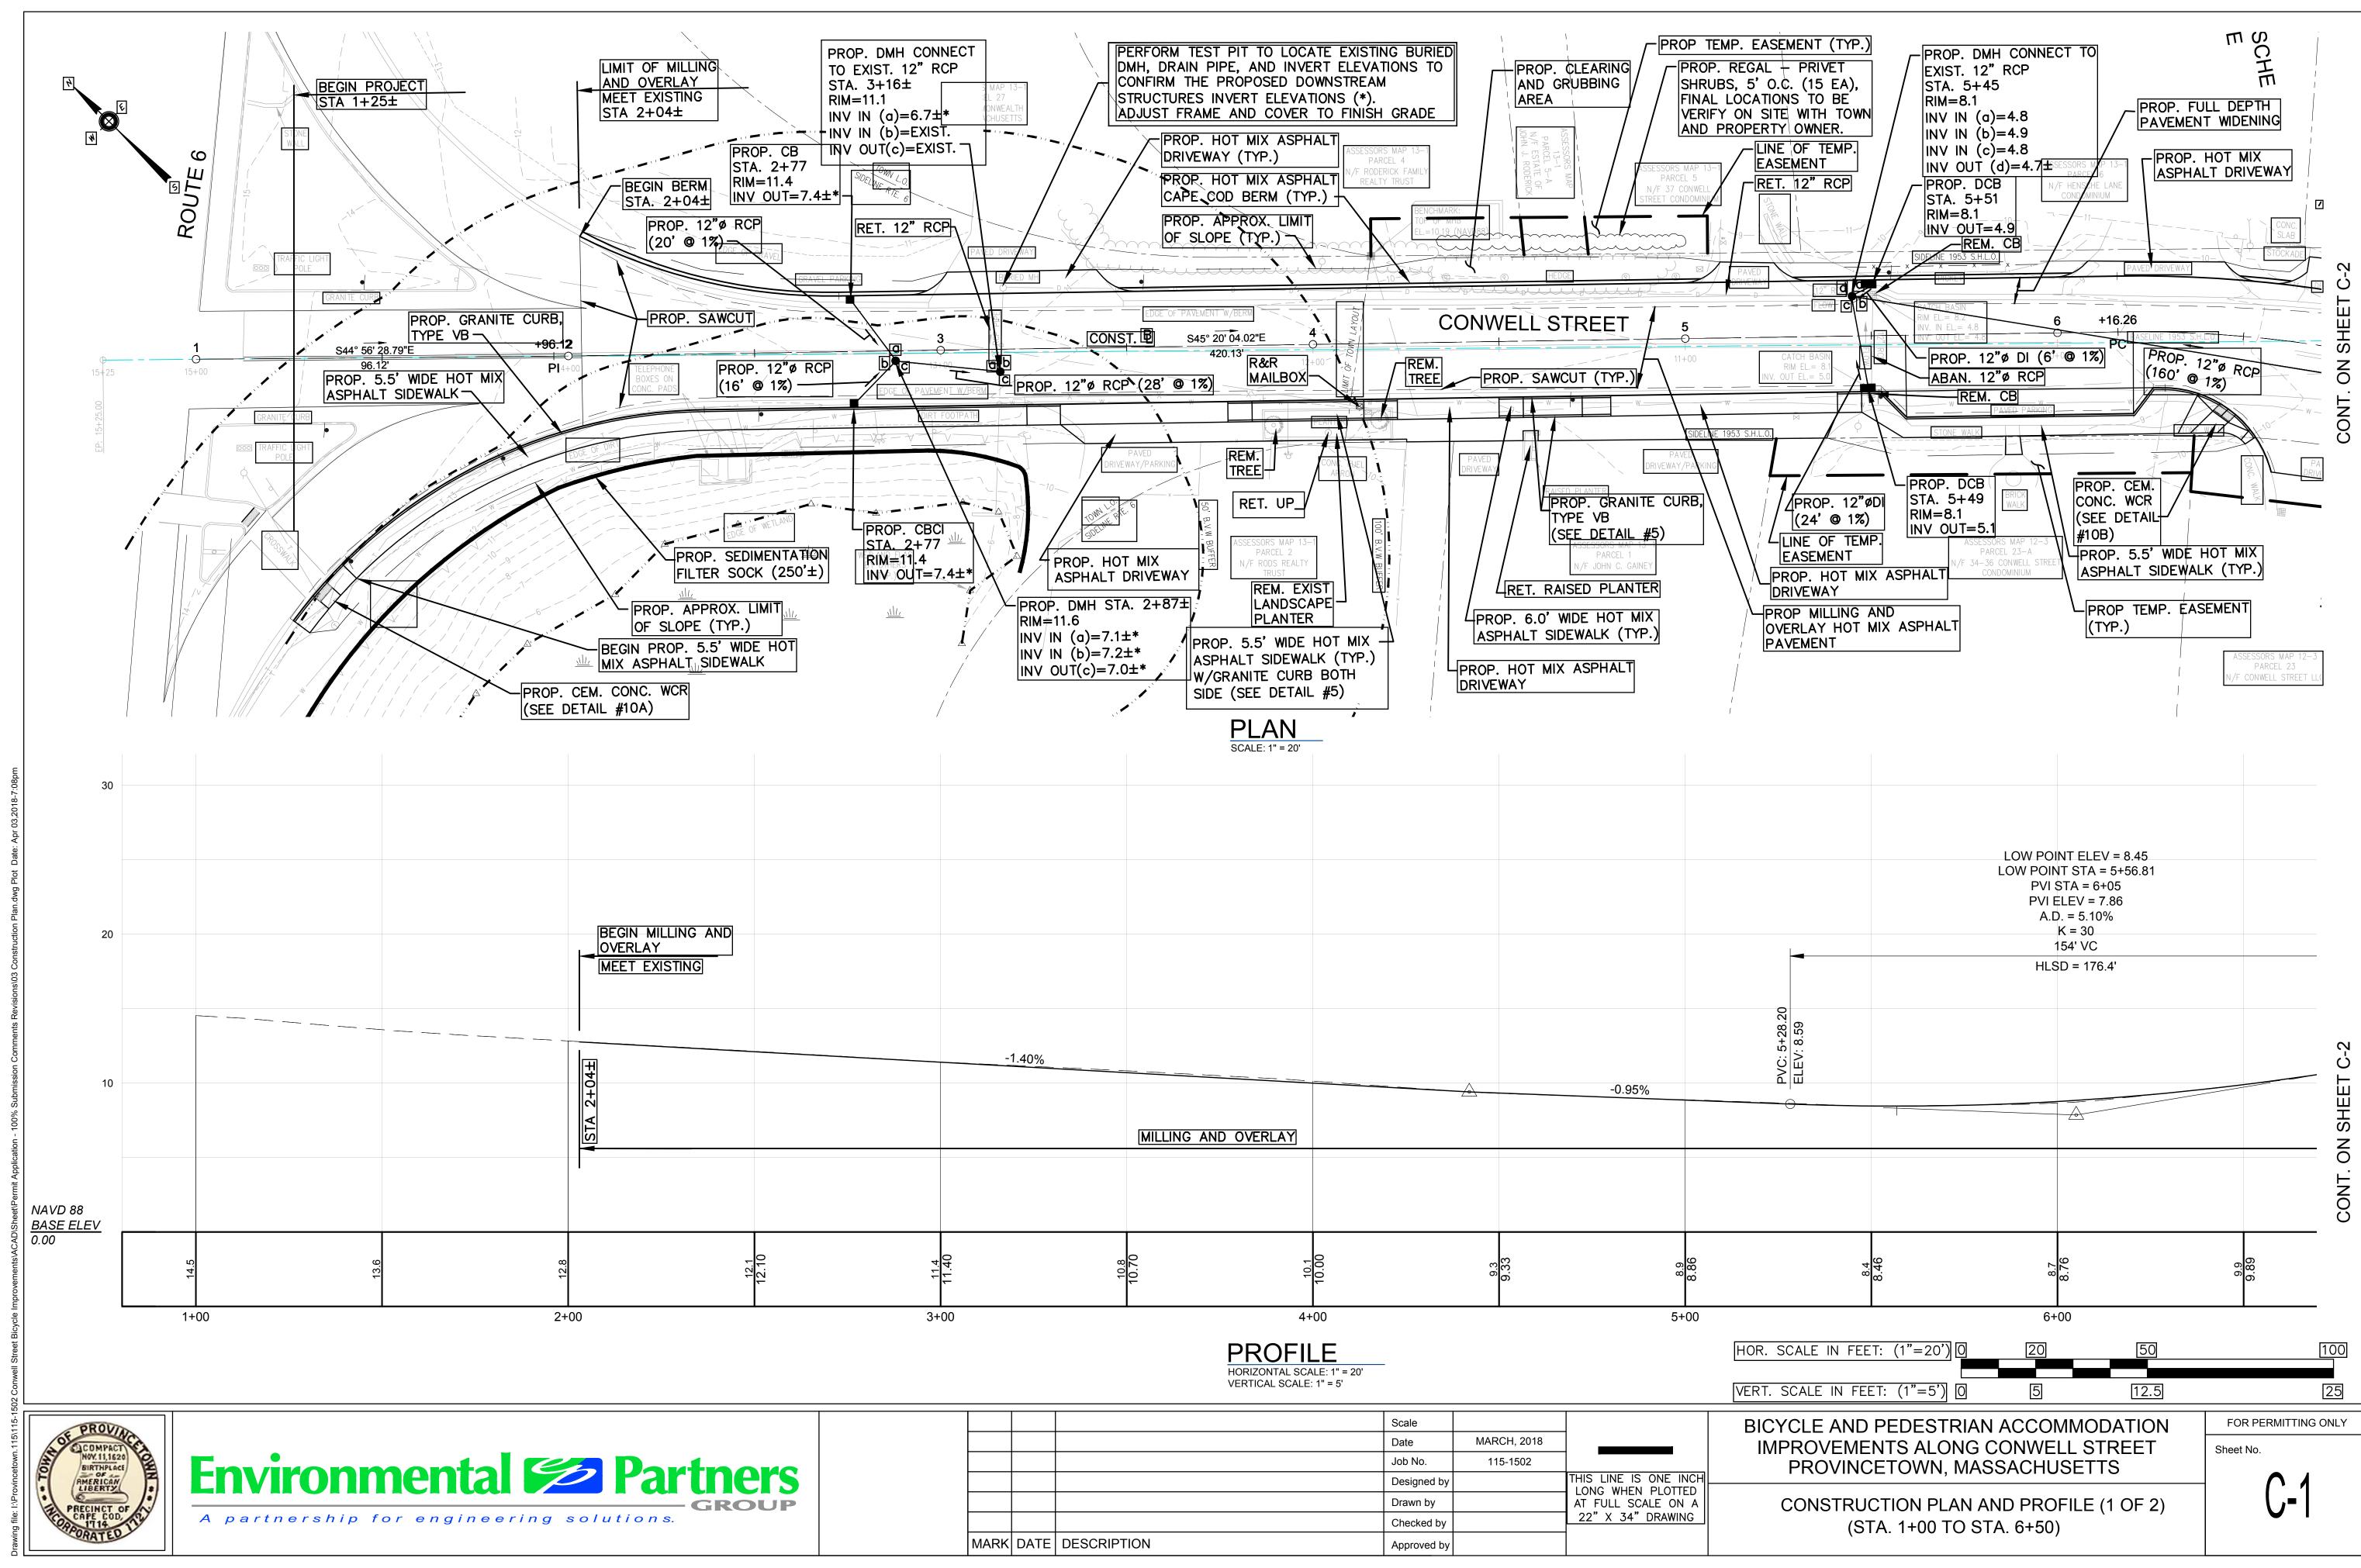
BICYCLE AND PEDESTRIAN ACCOMMODATION IMPROVEMENTS ALONG CONWELL STREET PROVINCETOWN, MASSACHUSETTS

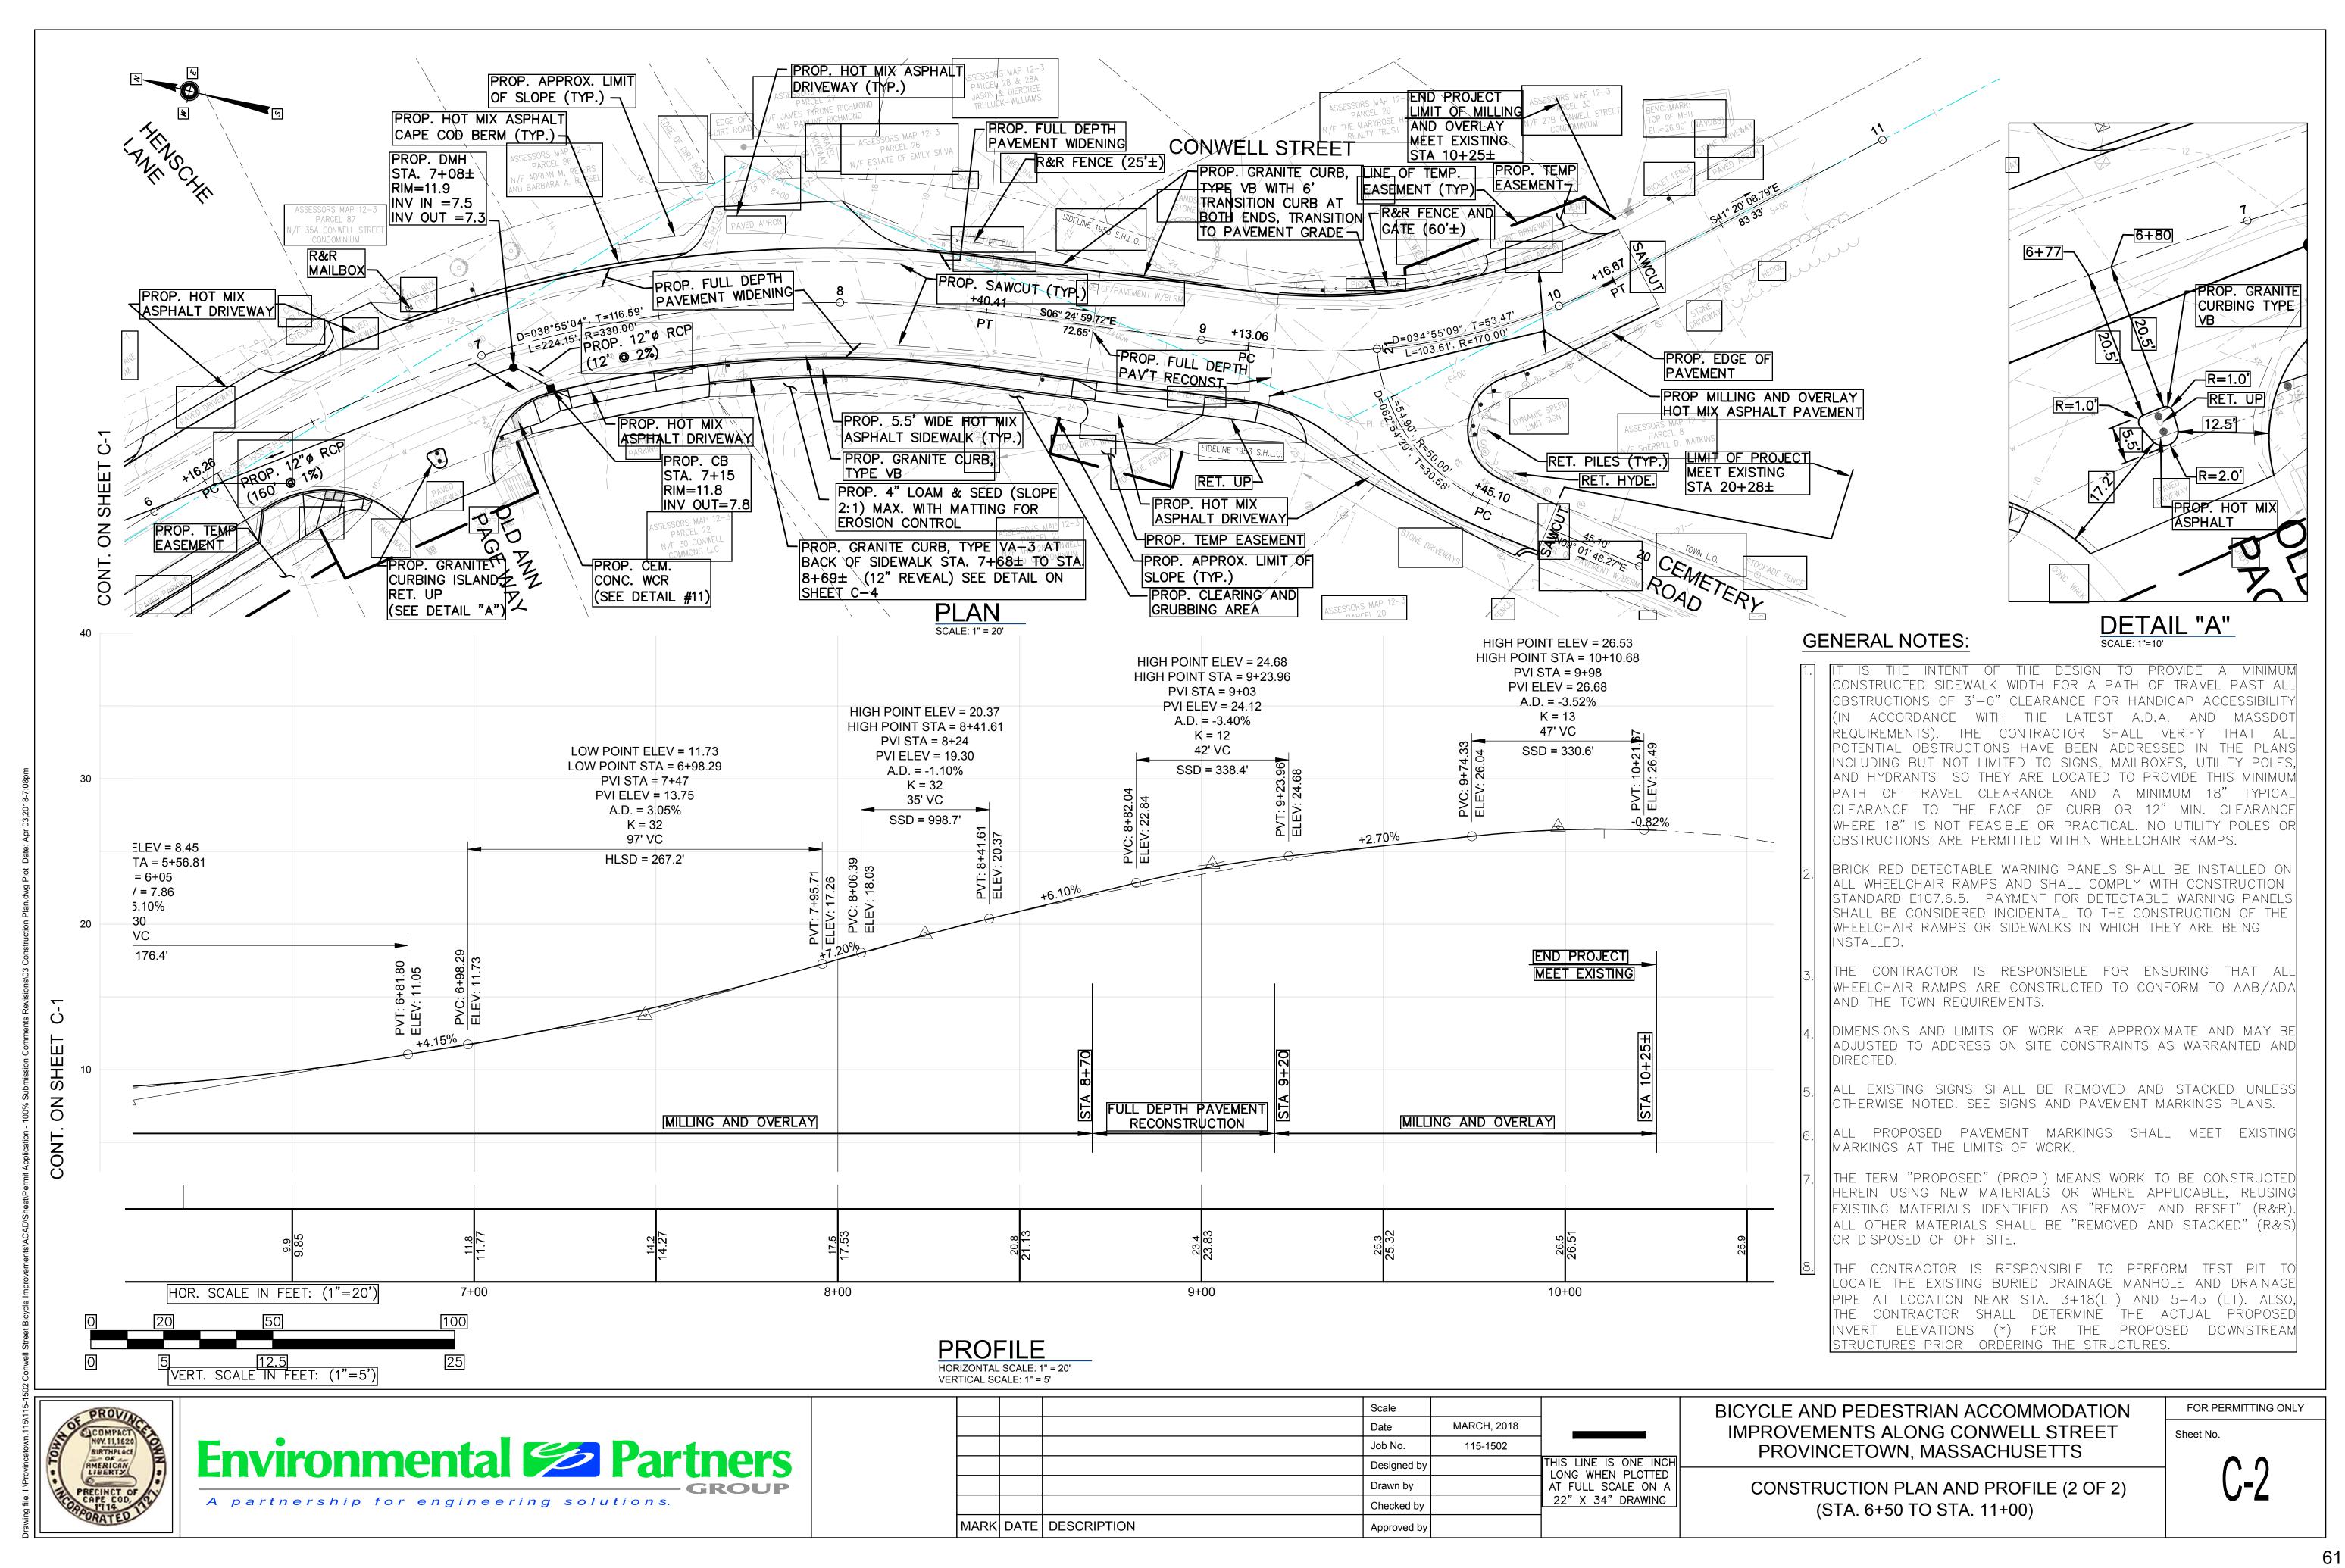
GENERAL NOTES AND LEGEND

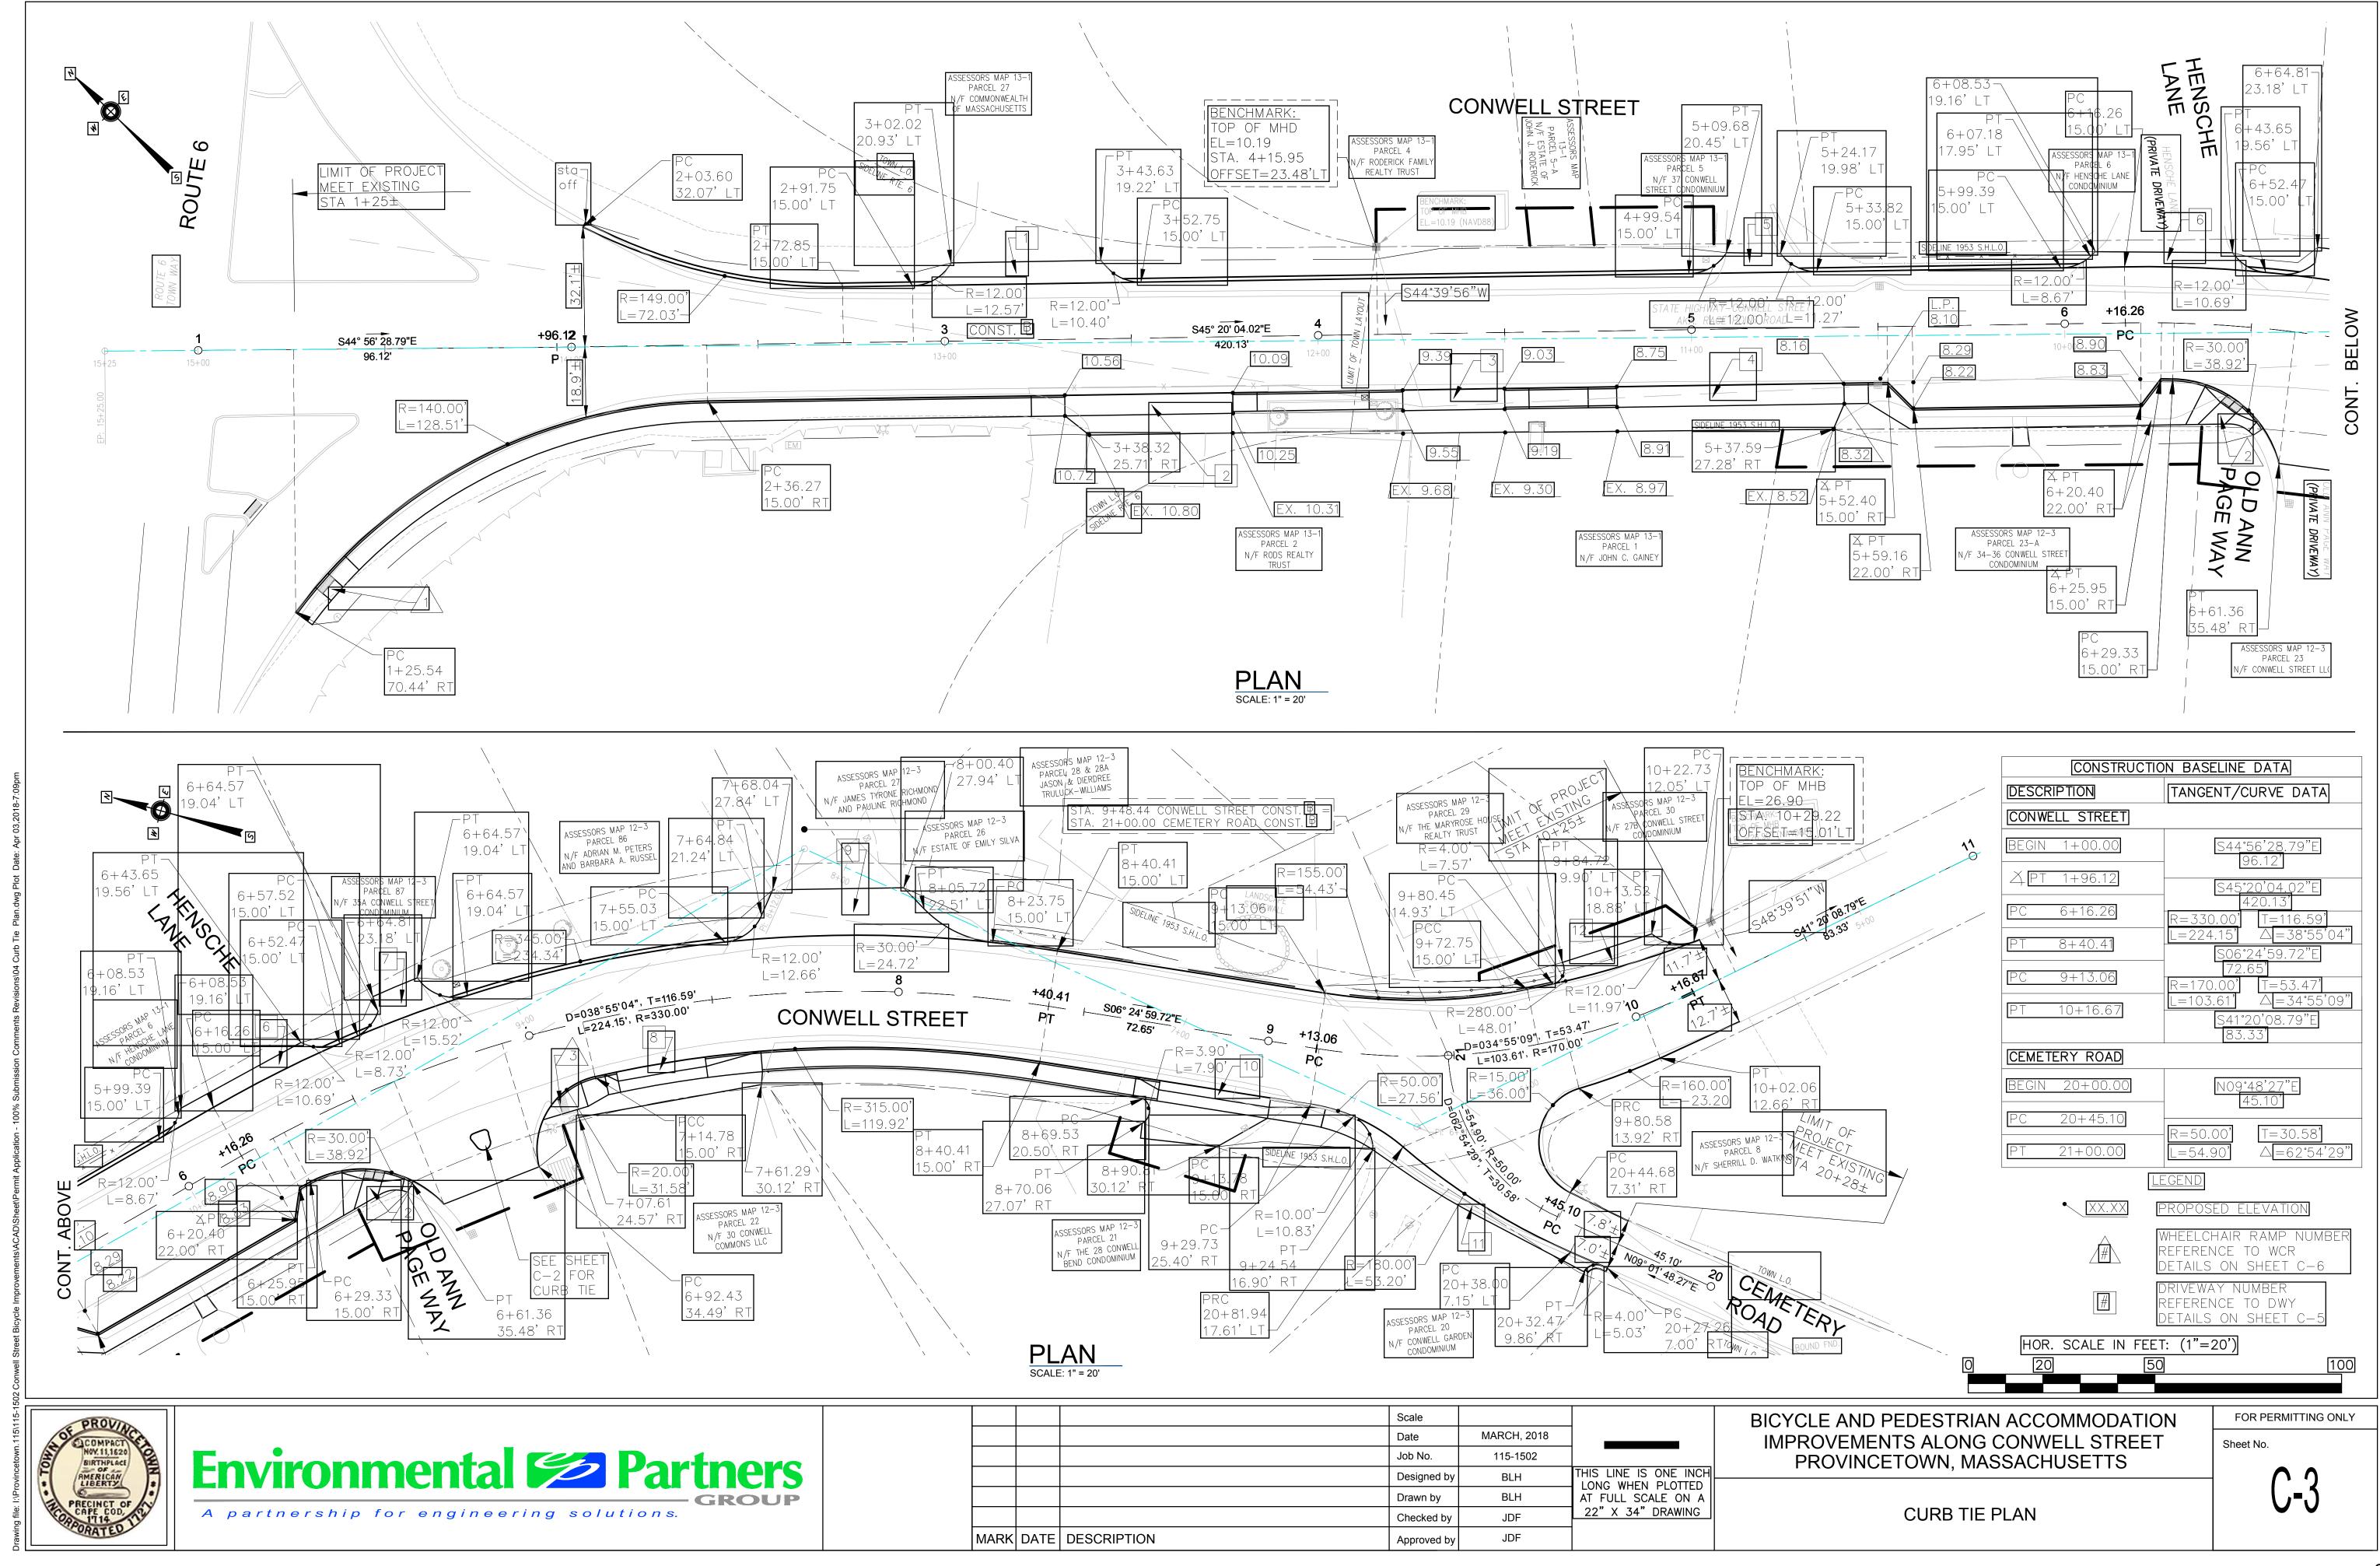
Sheet No.

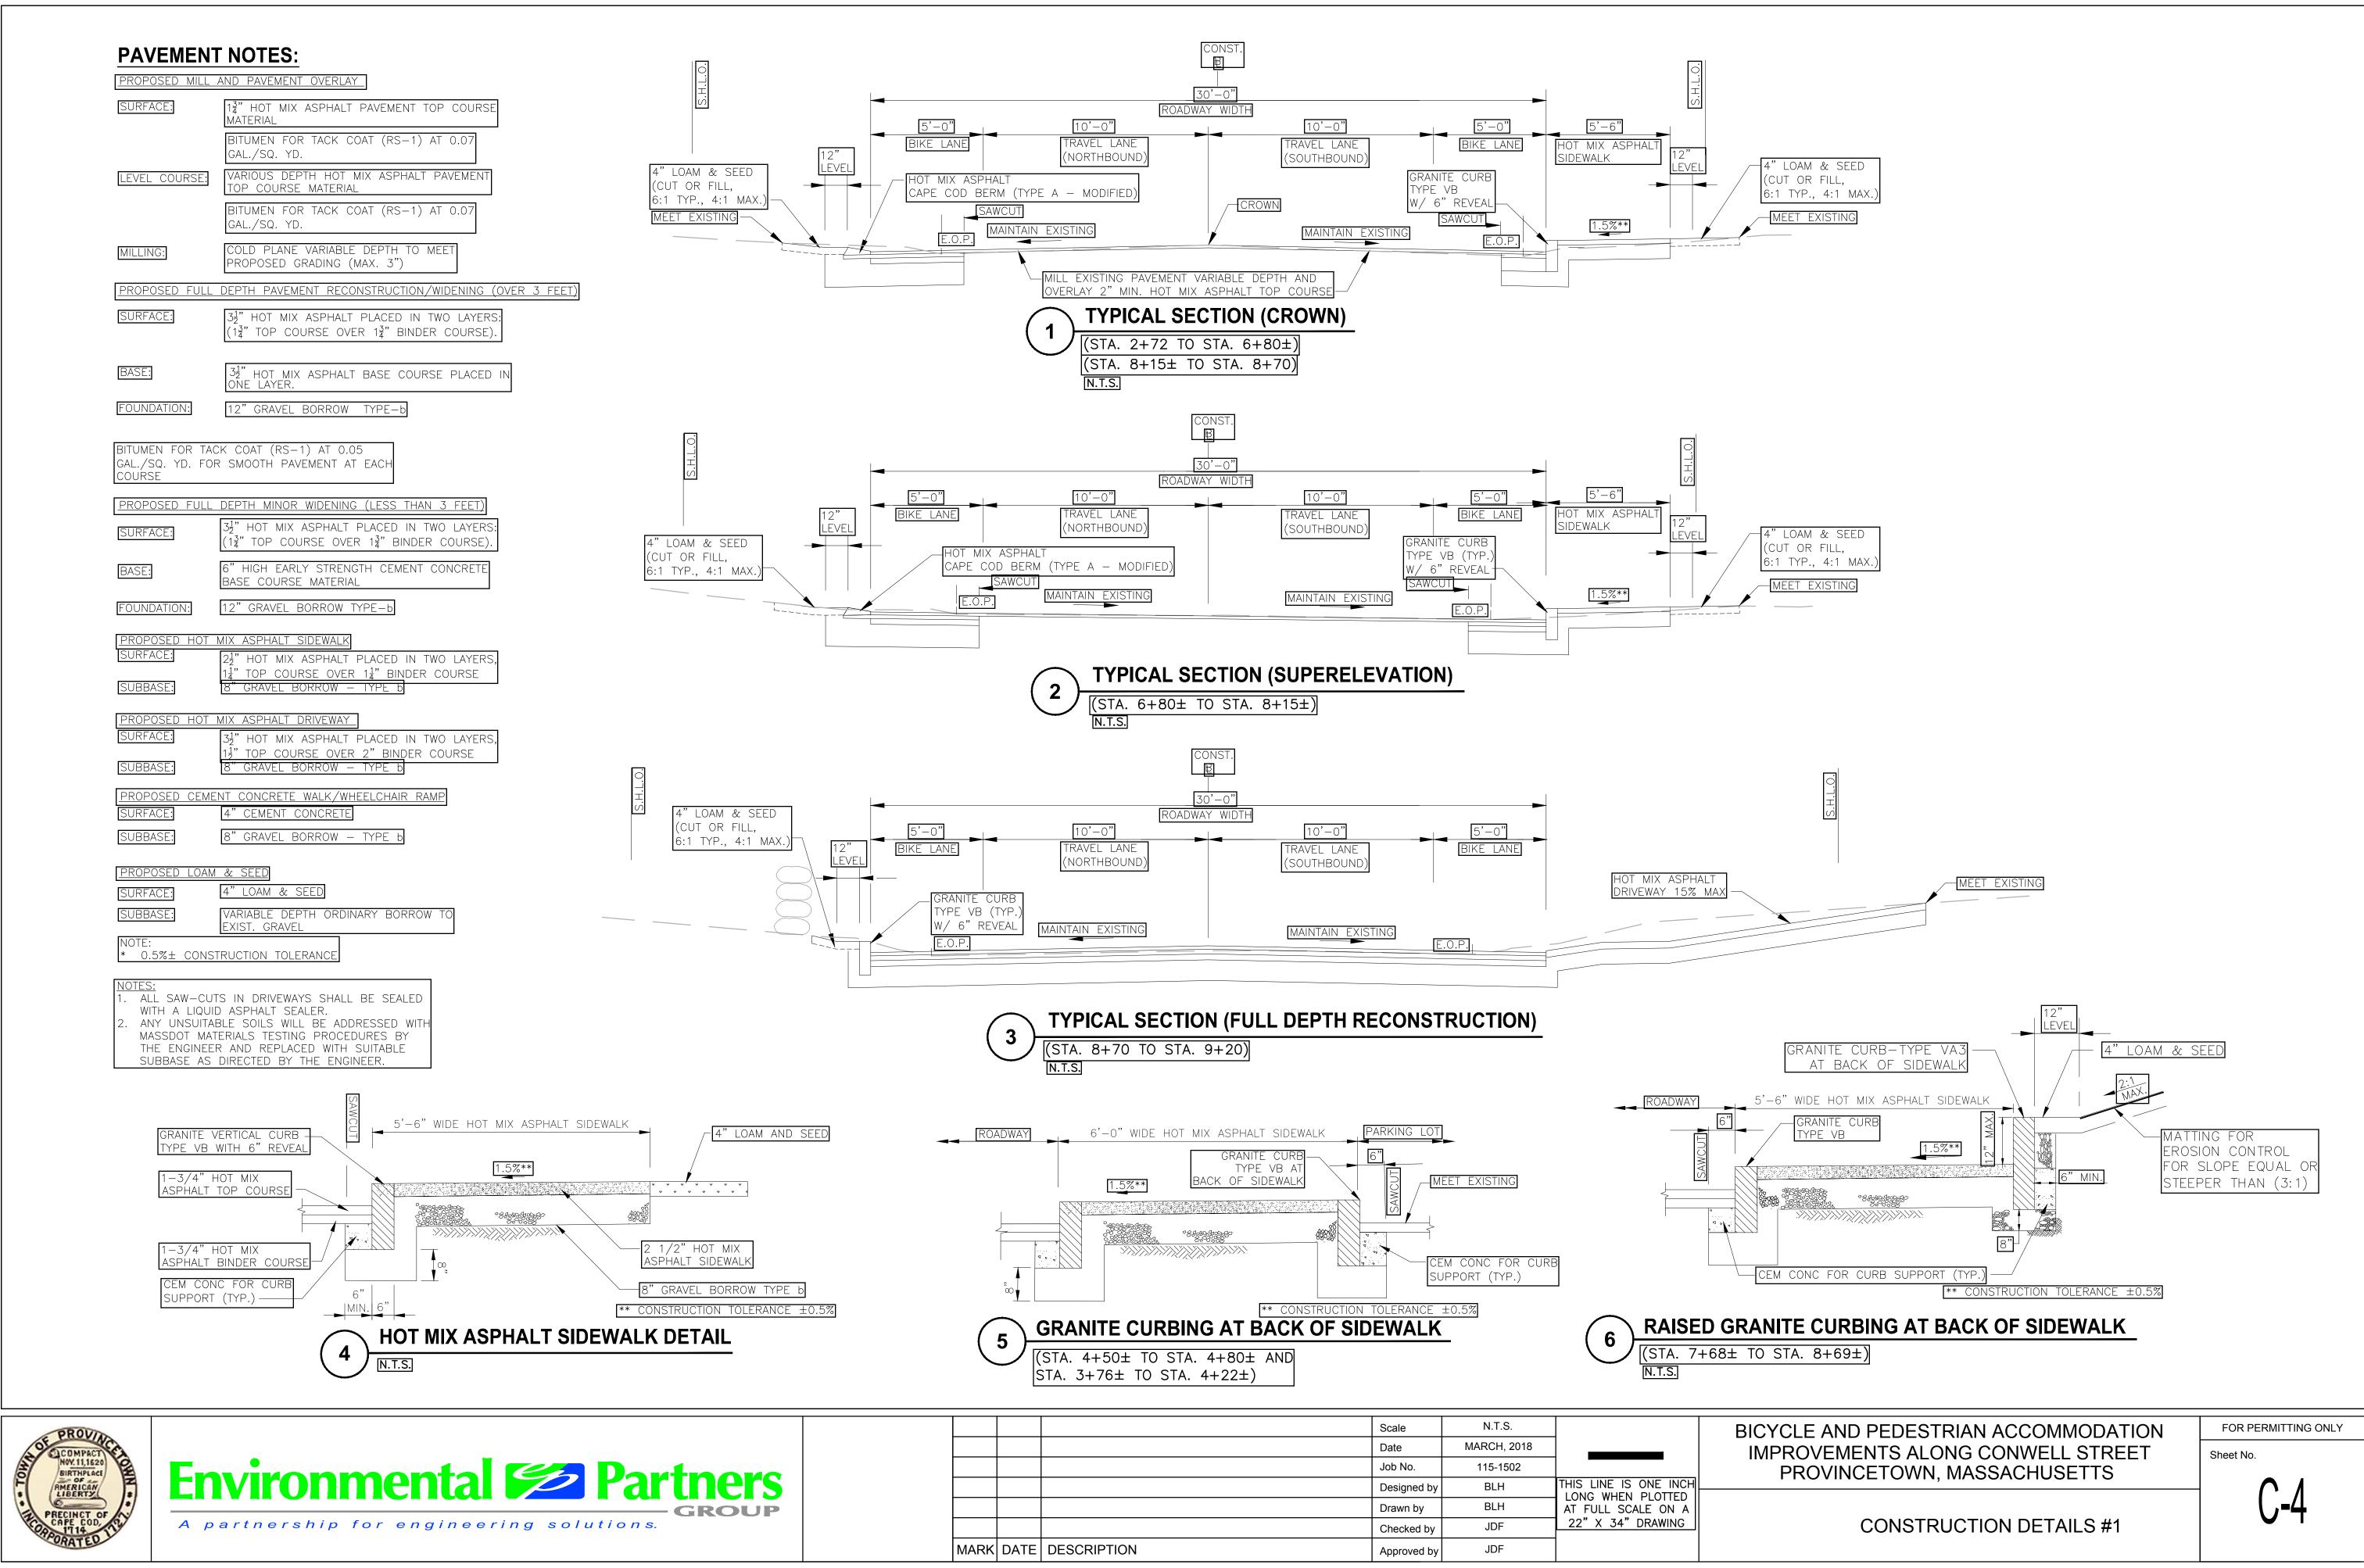
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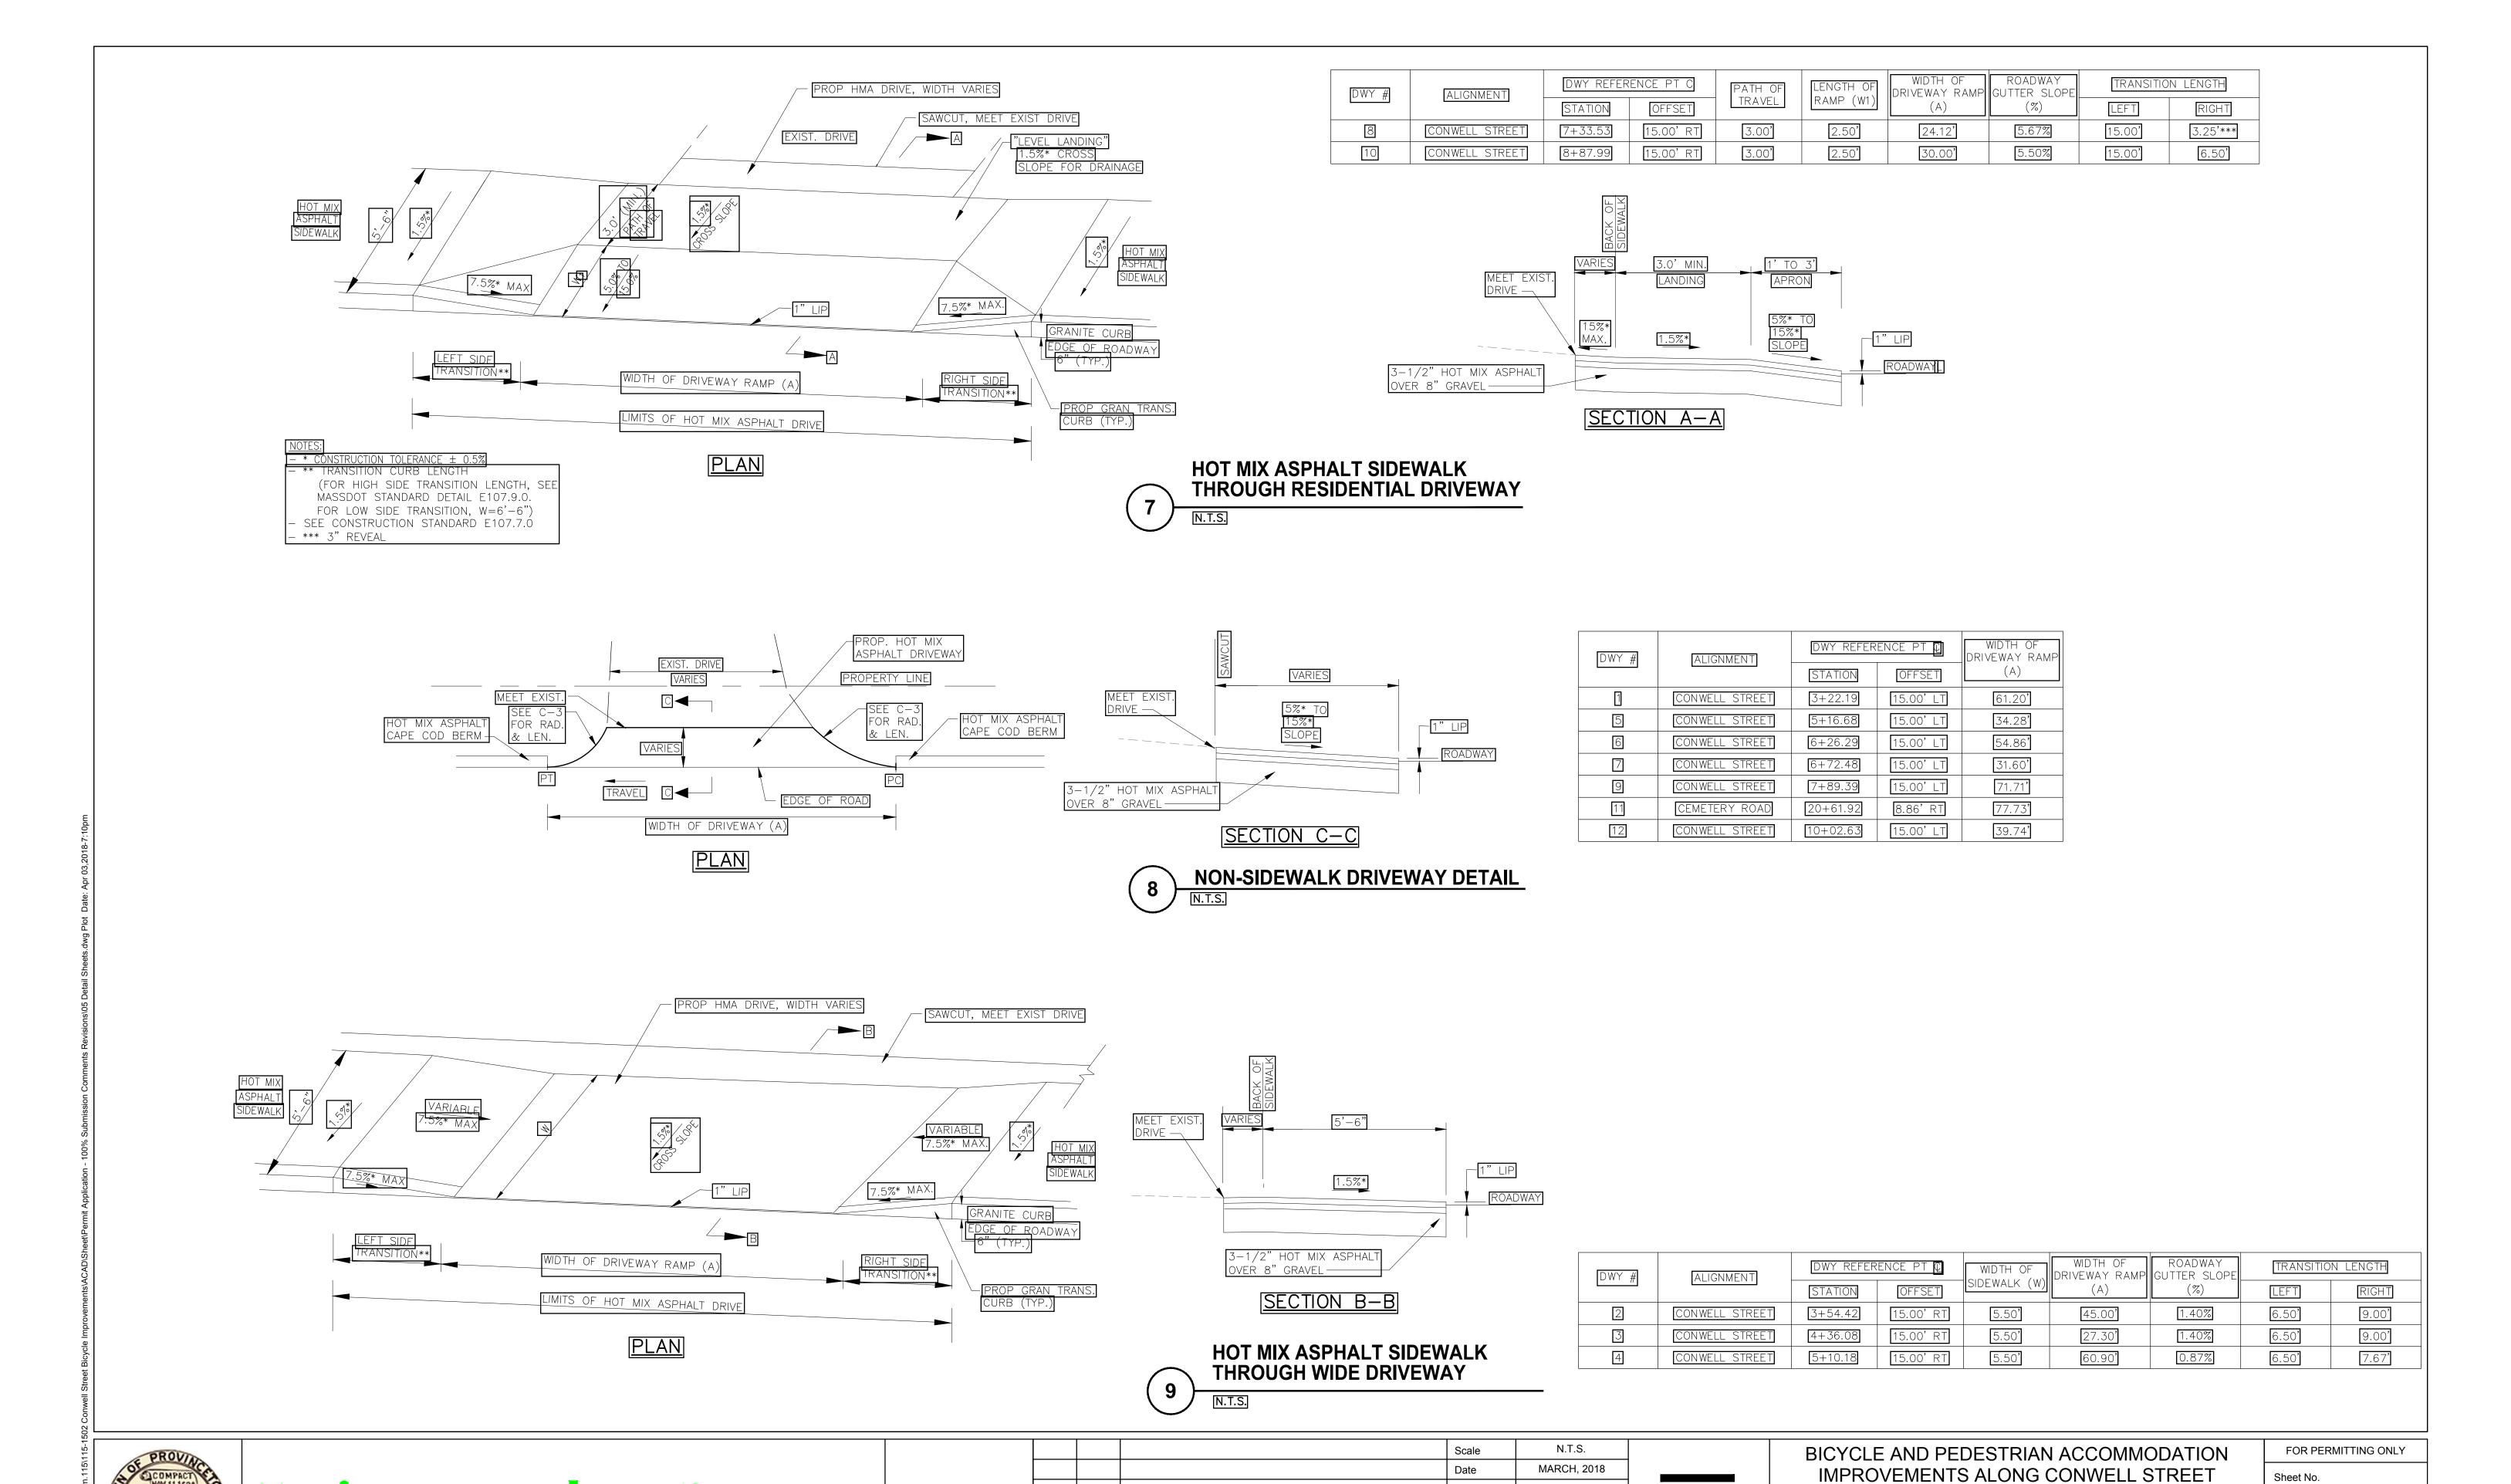
FOR PERMITTING ONLY











MARK DATE DESCRIPTION

Job No.

Designed by

Checked by

Approved by

Drawn by

115-1502

BLH

JDF

JDF

THIS LINE IS ONE INCH

LONG WHEN PLOTTED AT FULL SCALE ON A

22" X 34" DRAWING

Environmental Partners

A partnership for engineering solutions.

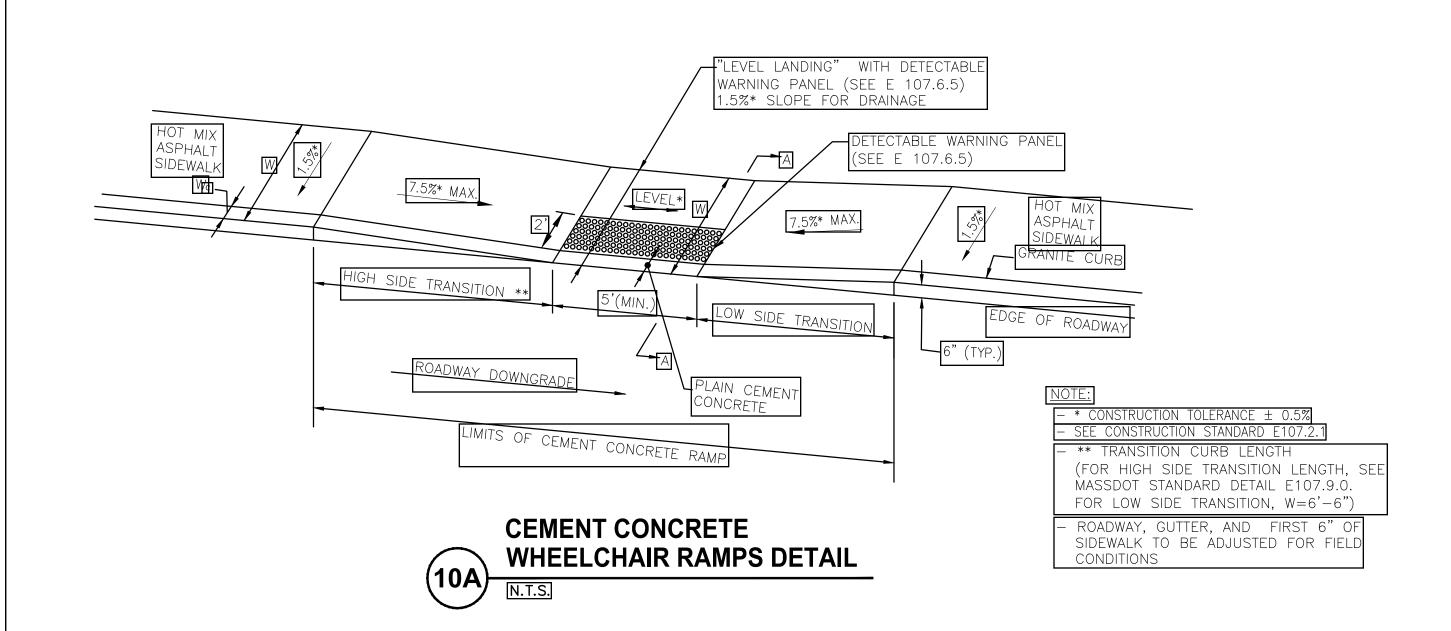
64

Sheet No.

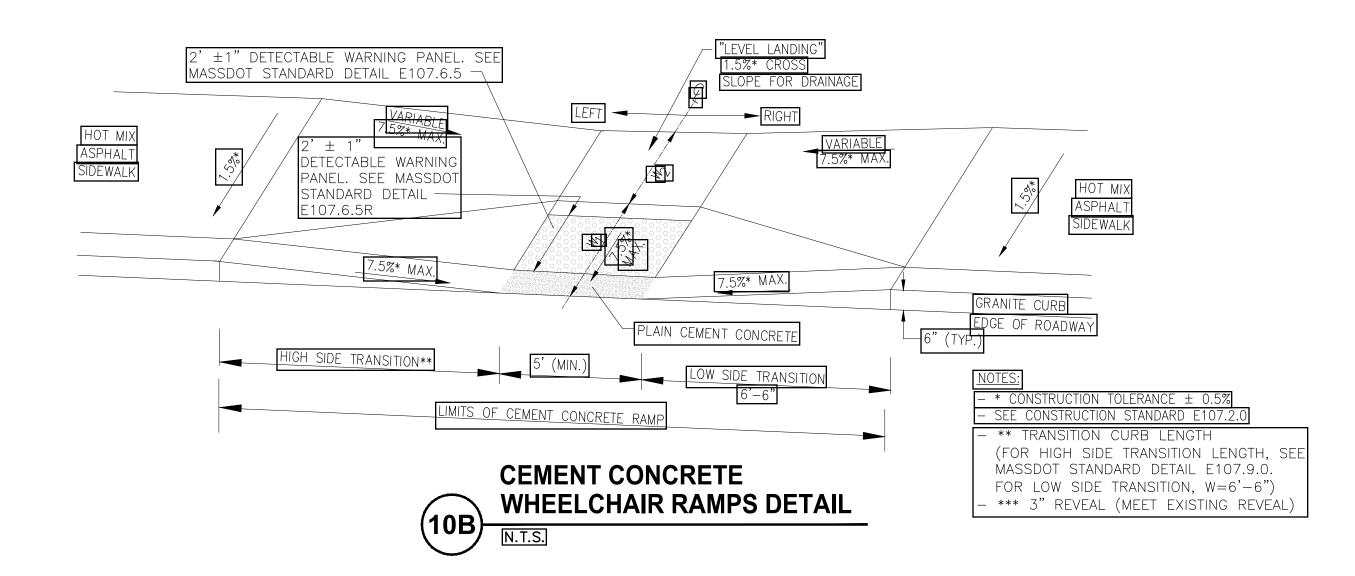
C-5

PROVINCETOWN, MASSACHUSETTS


CONSTRUCTION DETAILS #2








WCR #	ALIGNMENT	WCR REFER	WCR REFERENCE PT		PRIMARY RAMP LEVEL LANDING	WIDTH OF RAMP	ROADWAY GUTTER SLOPE	TRANSITION LENGTH	
11311		STATION	OFFSET	(W <u>1</u>)	DEPTH (W2)	(MIN. 5.00')	(%)	LEFT	RIGHT
2	CONWELL STREET	6+47.43	19.79' RT	2.90'	6.24'	5.00'	2.75%	5.5'***	6.50'

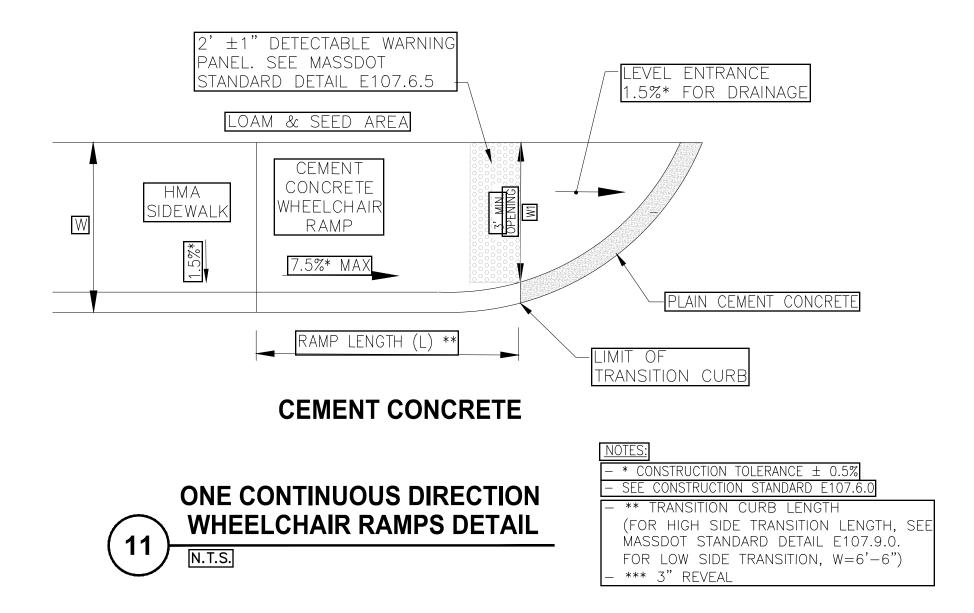

WCR #	ALIGNMENT	WCR REFER	ENCE PT (C)	WIDTH OF SIDEWALK (W)	[WIDTH OF OPENING (W1)]	ROADWAY GUTTER SLOPE	LENGTH OF RAMP (L)
	METOTIMETT	STATION	OFFSET			(%)	
3	CONWELL STREET	7+00.65	19.77' RT	6.87	4.00'	5.70%	7.50'***

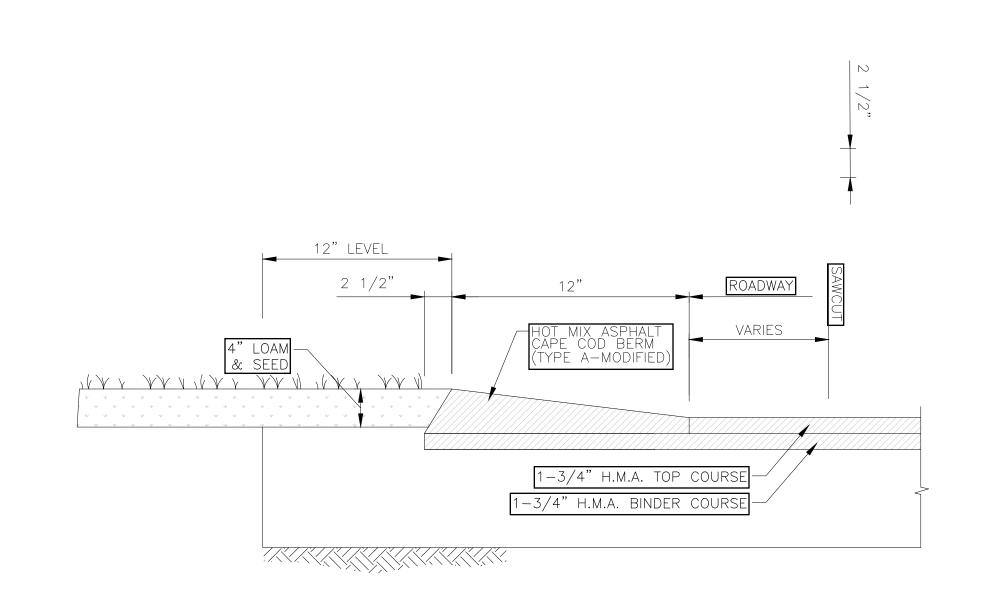

HOT MIX ASPHALT
CAPE COD BERM
(TYPE A MODIFIED)

N.T.S.




1				N.T.S.	
			Scale	IV. 1.5.	
			Date	MARCH, 2018	
			Job No.	115-1502	
			Designed by	BLH	THIS LINE IS ONE INCH LONG WHEN PLOTTED
			Drawn by	BLH	AT FULL SCALE ON A
			Checked by	JDF	22" X 34" DRAWING
MARK	DATE	DESCRIPTION	Approved by	JDF	


BICYCLE AND PEDESTRIAN ACCOMMODATION IMPROVEMENTS ALONG CONWELL STREET PROVINCETOWN, MASSACHUSETTS

CONSTRUCTION DETAILS #3

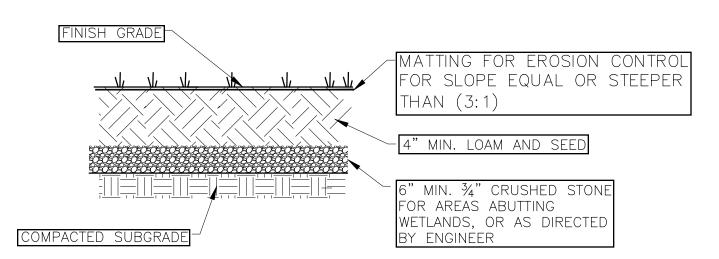Sheet No.




LOAM & SEED DETAIL N.T.S.

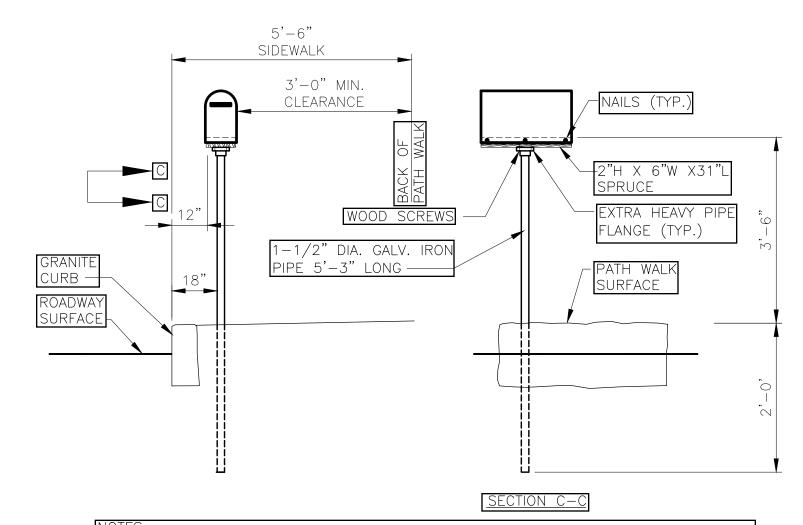


- LUMBER TO BE PLANED ON ALL FOUR SIDES TO FULL 2" X 6" SIZE TO FIT BOTTOM OF MAIL BOXES.
- TO SET 1-1/2" GALVANIZED POST, USE DRIVING POINT OF SAME SIZE, THEN TAMP POST INTO PLACE SO AS TO BE PLUMB BOTH WAYS.
 ALL FITTINGS (PIPE FLANGES, PIPE, SCREWS, NAILS, ETC.) ARE TO BE GALVANIZED.
 FOR DESCRIPTIONS, MATERIALS AND CONSTRUCTION METHODS SEE STANDARD CT
- DOT SPECIFICATIONS.

 MAIL BOXES ON NARROW SIDEWALKS SHOULD BE SET BEHIND CURB AND PARALLEI
 TO IT WITH LETTER SLOT FACING TRAFFIC

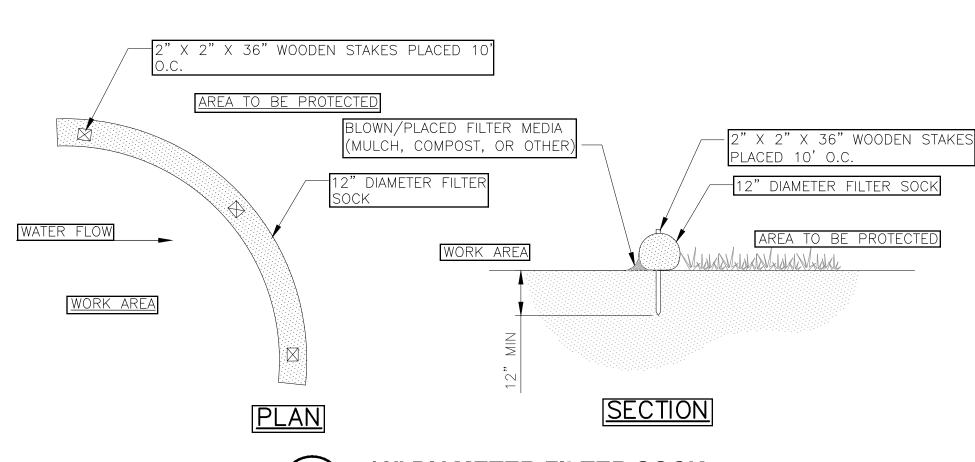
RURAL MAILBOX DETAIL ALONG PATH WALK




15 12" DIAMETER FILTER SOCK

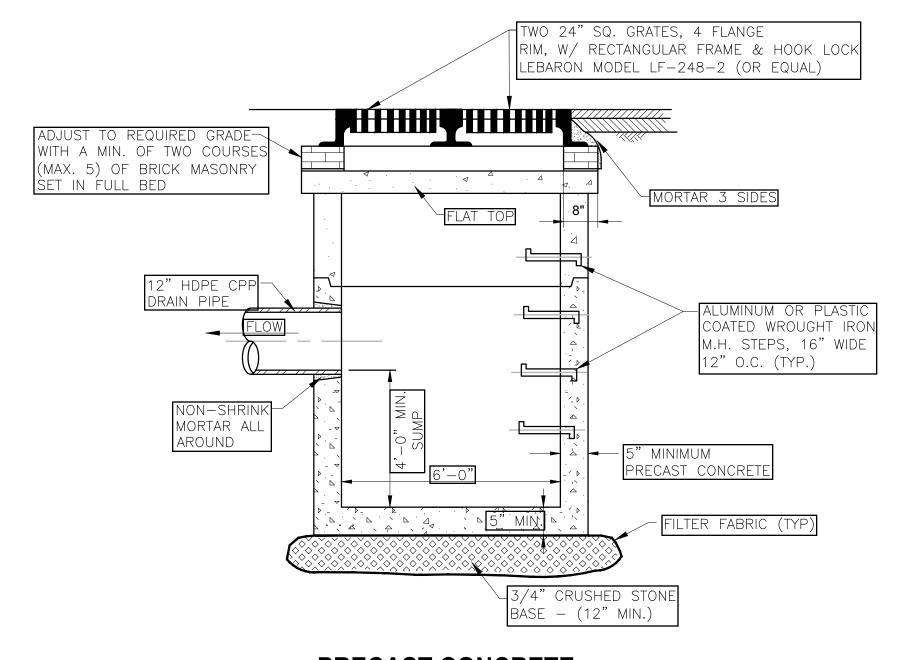




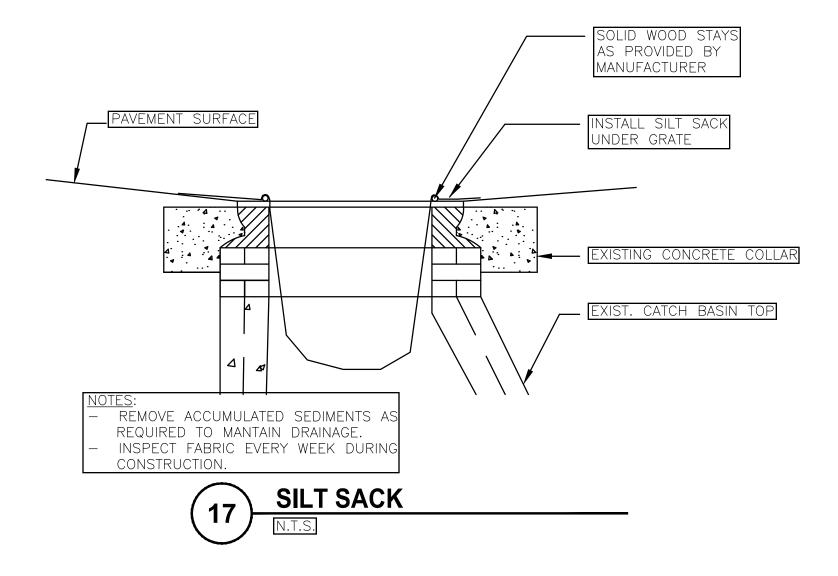

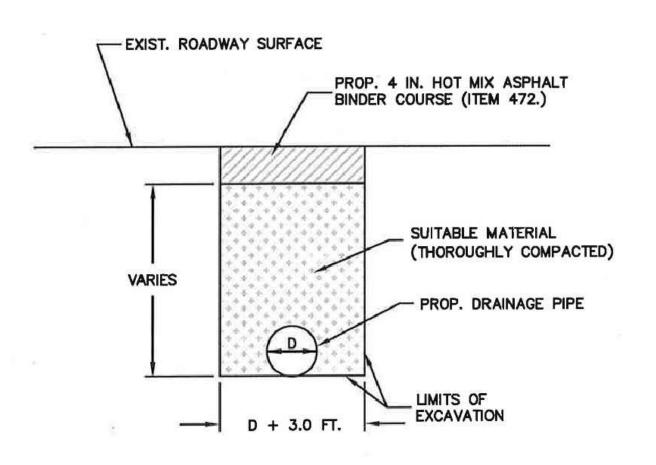

TEMPORARY PATCH

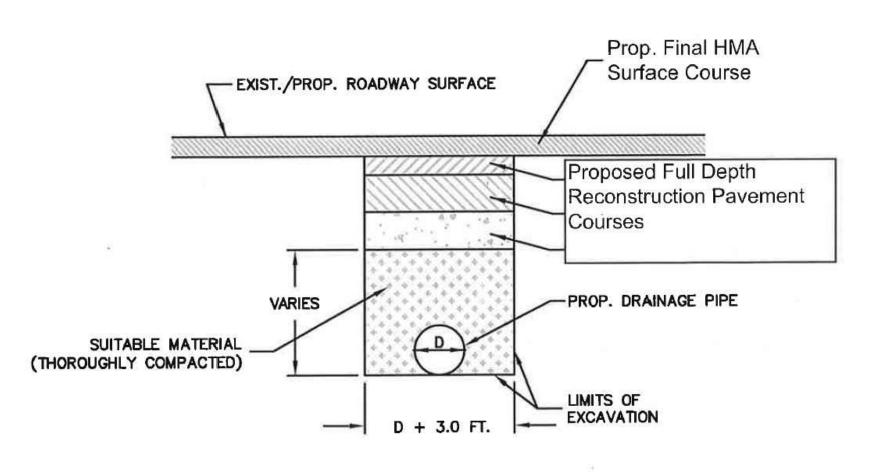(FULL DEPTH ROADWAY RECONSTRUCTION)



PERMANENT PATCH (MILLING/OVERLAY)

PROPOSED DRAINAGE TRENCH
IN ROADWAY

N.T.S.




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			Date	MARCH, 2018	
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BICYCLE AND PEDESTRIAN ACCOMMODATION IMPROVEMENTS ALONG CONWELL STREET PROVINCETOWN, MASSACHUSETTS


CONSTRUCTION DETAIL #4

Sheet No.

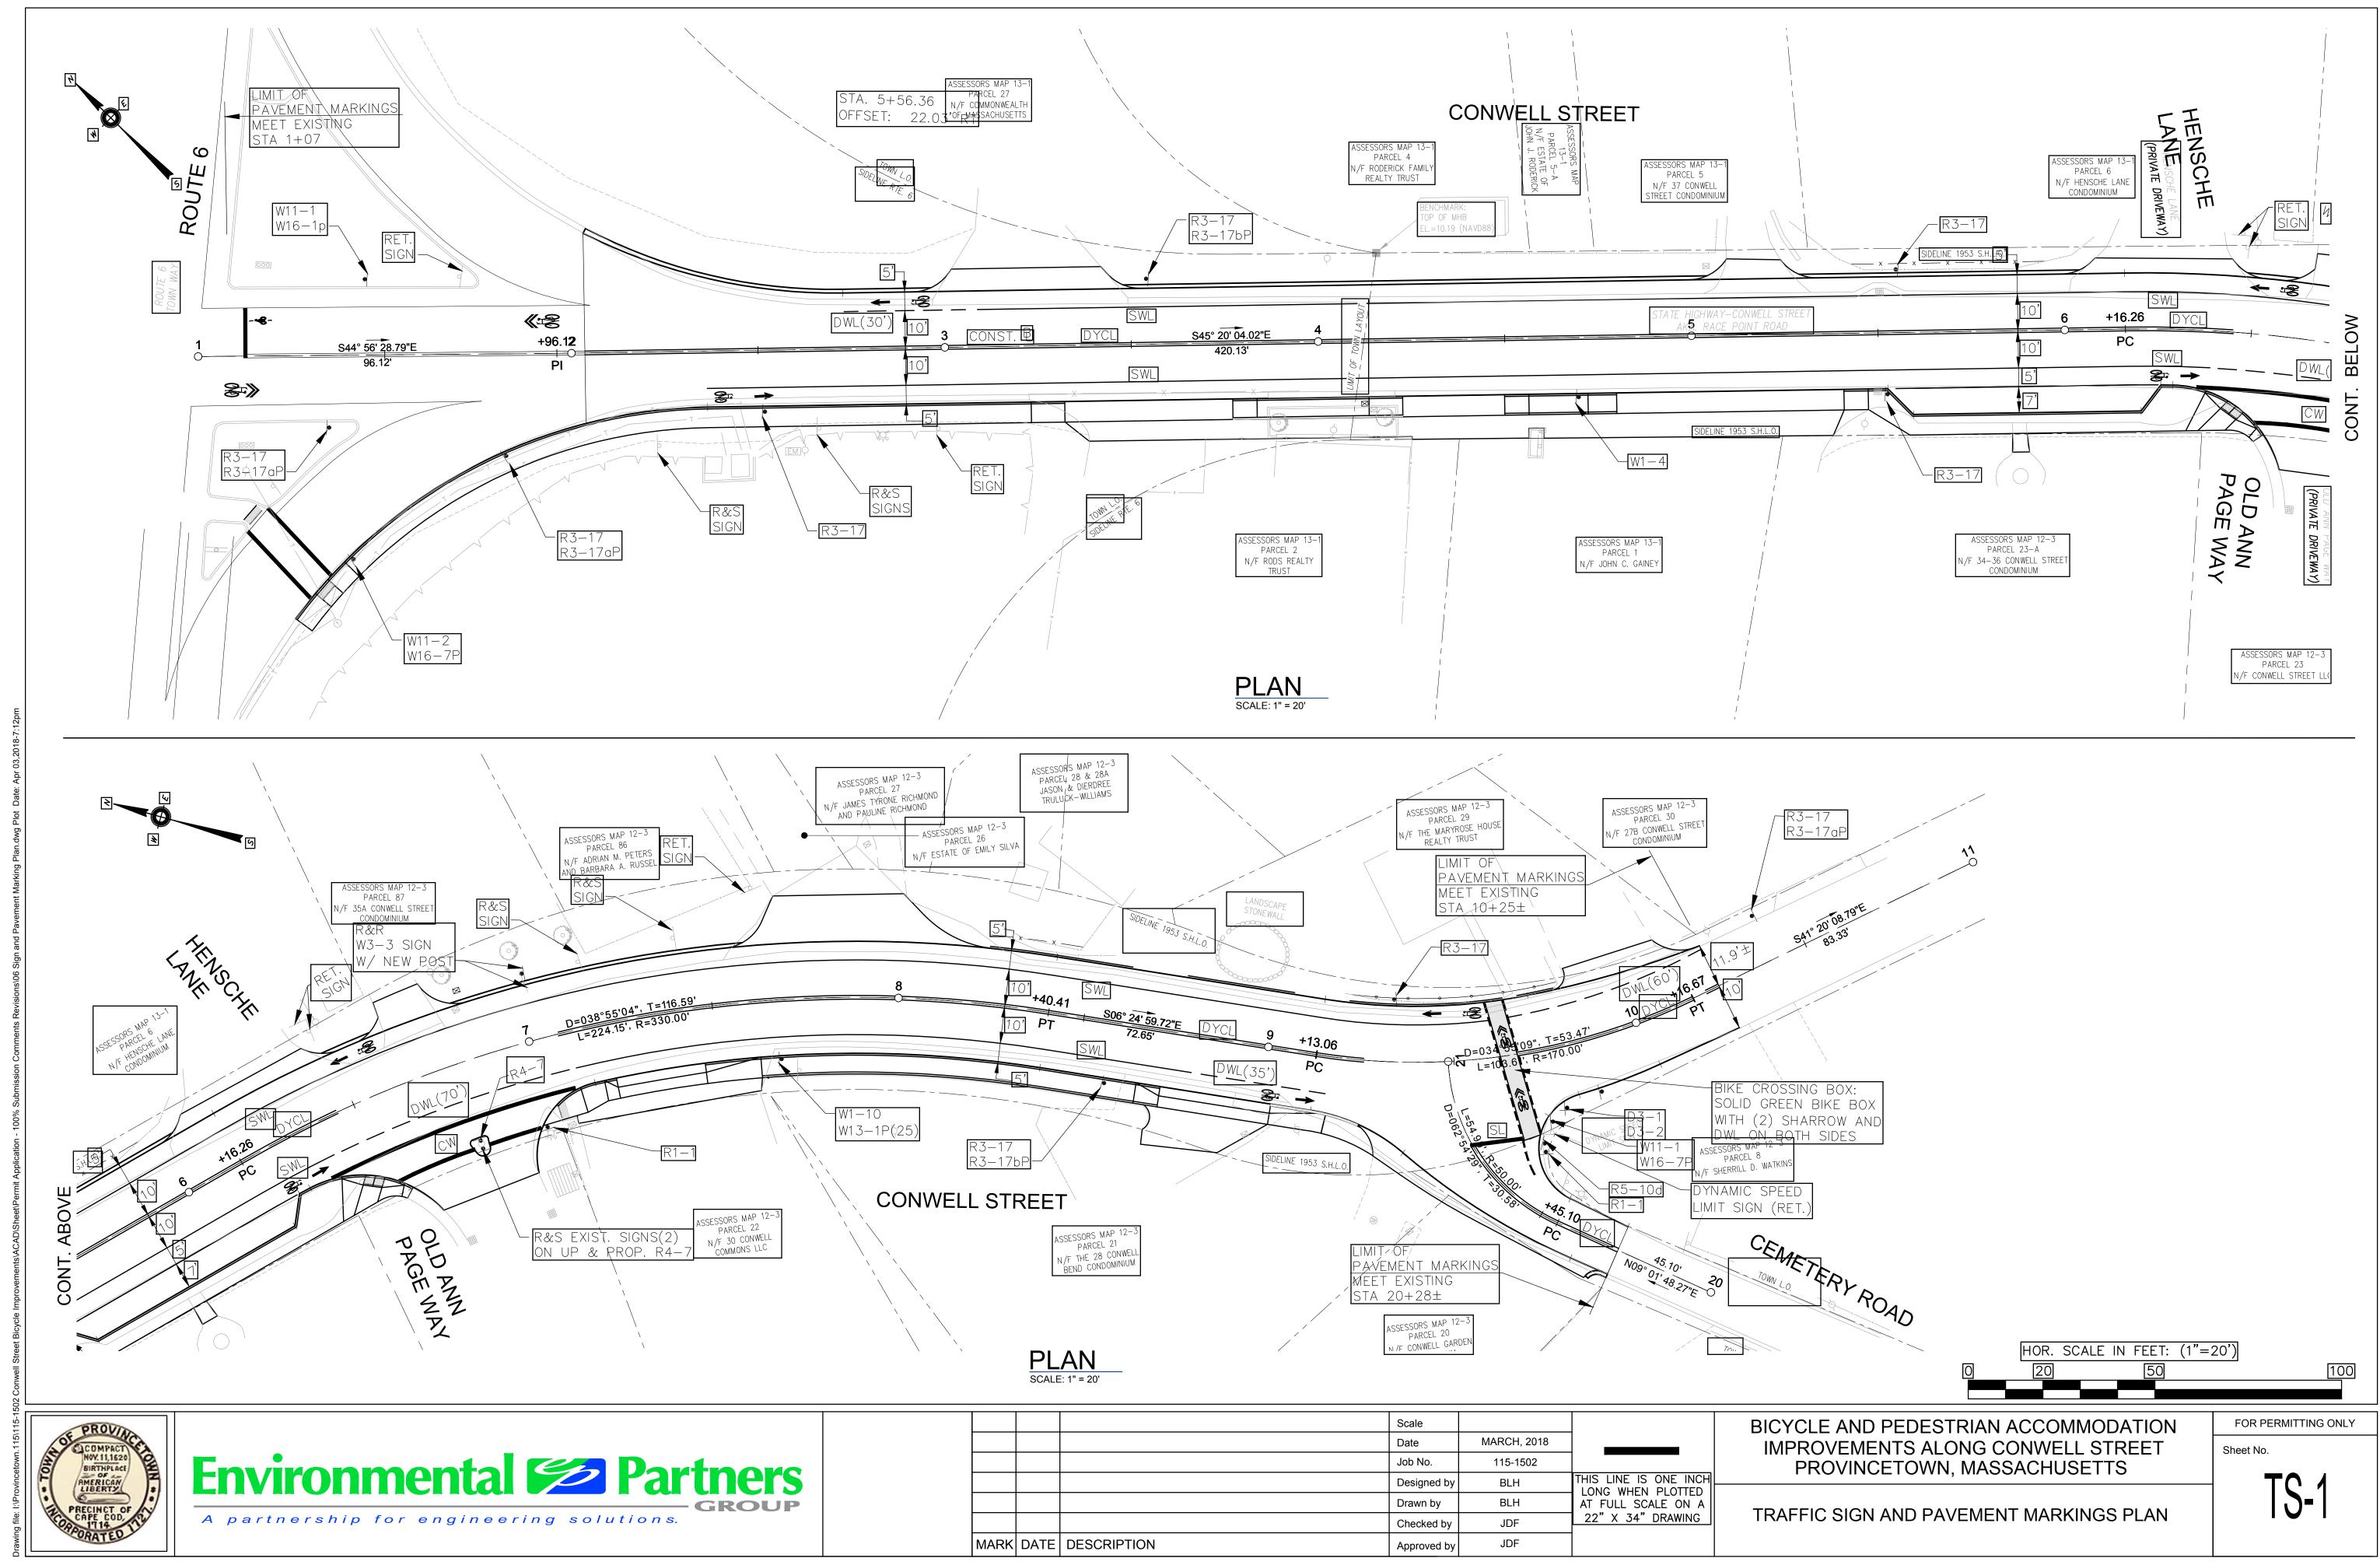FOR PERMITTING ONLY



[DENTIFI-] [CATION] [NUMBER]	SIZE C (INCH WIDTH	DF SIGN HES) HEIGHT	TEXT	TEXT DIMENS LETTER HEIGHT	SIONS (INCHES) VERTICAL SPACING	SIGNS	BACK- LEG	OR BORDER	POST SIZE AND NUMBER REQUIRED	UNIT AREA IN SQUARE FEET	AREA IN SQUARE FEET
D3-1	VARIES	18	Conwell St	MU	TCD IDARD	1	MU' STAN	TCD DARD	P5 (1)	EACH	EACH
D3-2	VARIES	18	Cemetery Rd			1			MOUNT W/ D3-1 (1)	EACH	EACH
R1-1	30	30	STOP			2			P5 (2)	6.25	12.50
R3-17	30	24	BIKE LANE			9			P5 (9)	5.00	45.00
R3-17aP	24	8	AHEAD			3			MOUNT W/ R3-17 (3)	1.33	3.99
R3-17bP	24	8	ENDS			2			MOUNT W/ R3-17 (2)	1.33	2.66
R4-7	24	30				2			P5 (2)	5.00	10.00
R5-10d	30	36	NO CAMPERS TRAILERS BUSES			1			P5 (1)	7.50	7.50
[W1-4]	30	30				1			P5 (1)	6.25	6.25
W1-10	30	30				1			P5 (1)	6.25	6.25
W3-3						R&R (1)			P5 (1)	•	I
W11-1	30	30				1			P5 (1)	6.25	6.25
W11-2	30	30				1			P5 (1)	6.25	6.25
W13-1P (25)	18	18	XX M.P.H.			1			MOUNT W/ W1-10 (1)	2.25	2.25
W16-1P	18	24	SHARE THE ROAD			1			MOUNT W/ W11-1 (1)	3.00	3.00
W16-7P	[24]	12				1			MOUNT W/ W11-2 (1)	2.00	2.00

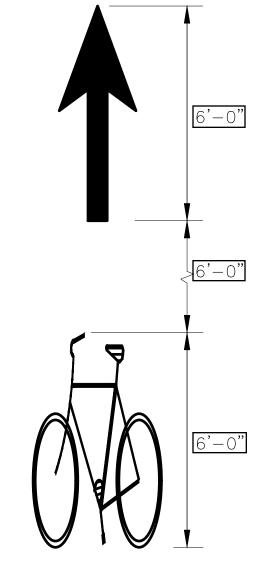


BICYCLE LANE MARKINGS NOT TO SCALE

NOTE:
ALL BICYCLE LANE AND SHARROW SYMBOL PAVEMENT
MARKINGS SHALL BE PAINT IN WHITE THERMOPLASTIC
AND COMPLY TO THE LATEST M.U.T.C.D STANDARD.

SHARED LANE MARKINGS NOT TO SCALE

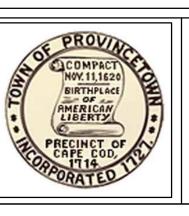SEE MANUAL ON UNIFORM TRAFFIC CONTROL DEVICES 2009 EDITION FOR LATEST REVISIONS AND MASSACHUSETTS AMENDMENTS FOR LATEST SPECIFICATIONS ON TEXT DIMENSIONS AND COLOR.





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BICYCLE AND PEDESTRIAN ACCOMMODATION IMPROVEMENTS ALONG CONWELL STREET PROVINCETOWN, MASSACHUSETTS

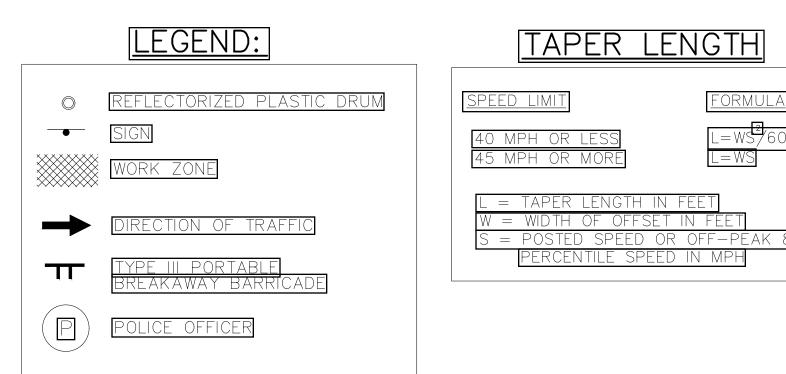
SIGN SUMMARY AND PAVEMENT MARKING DETAILS

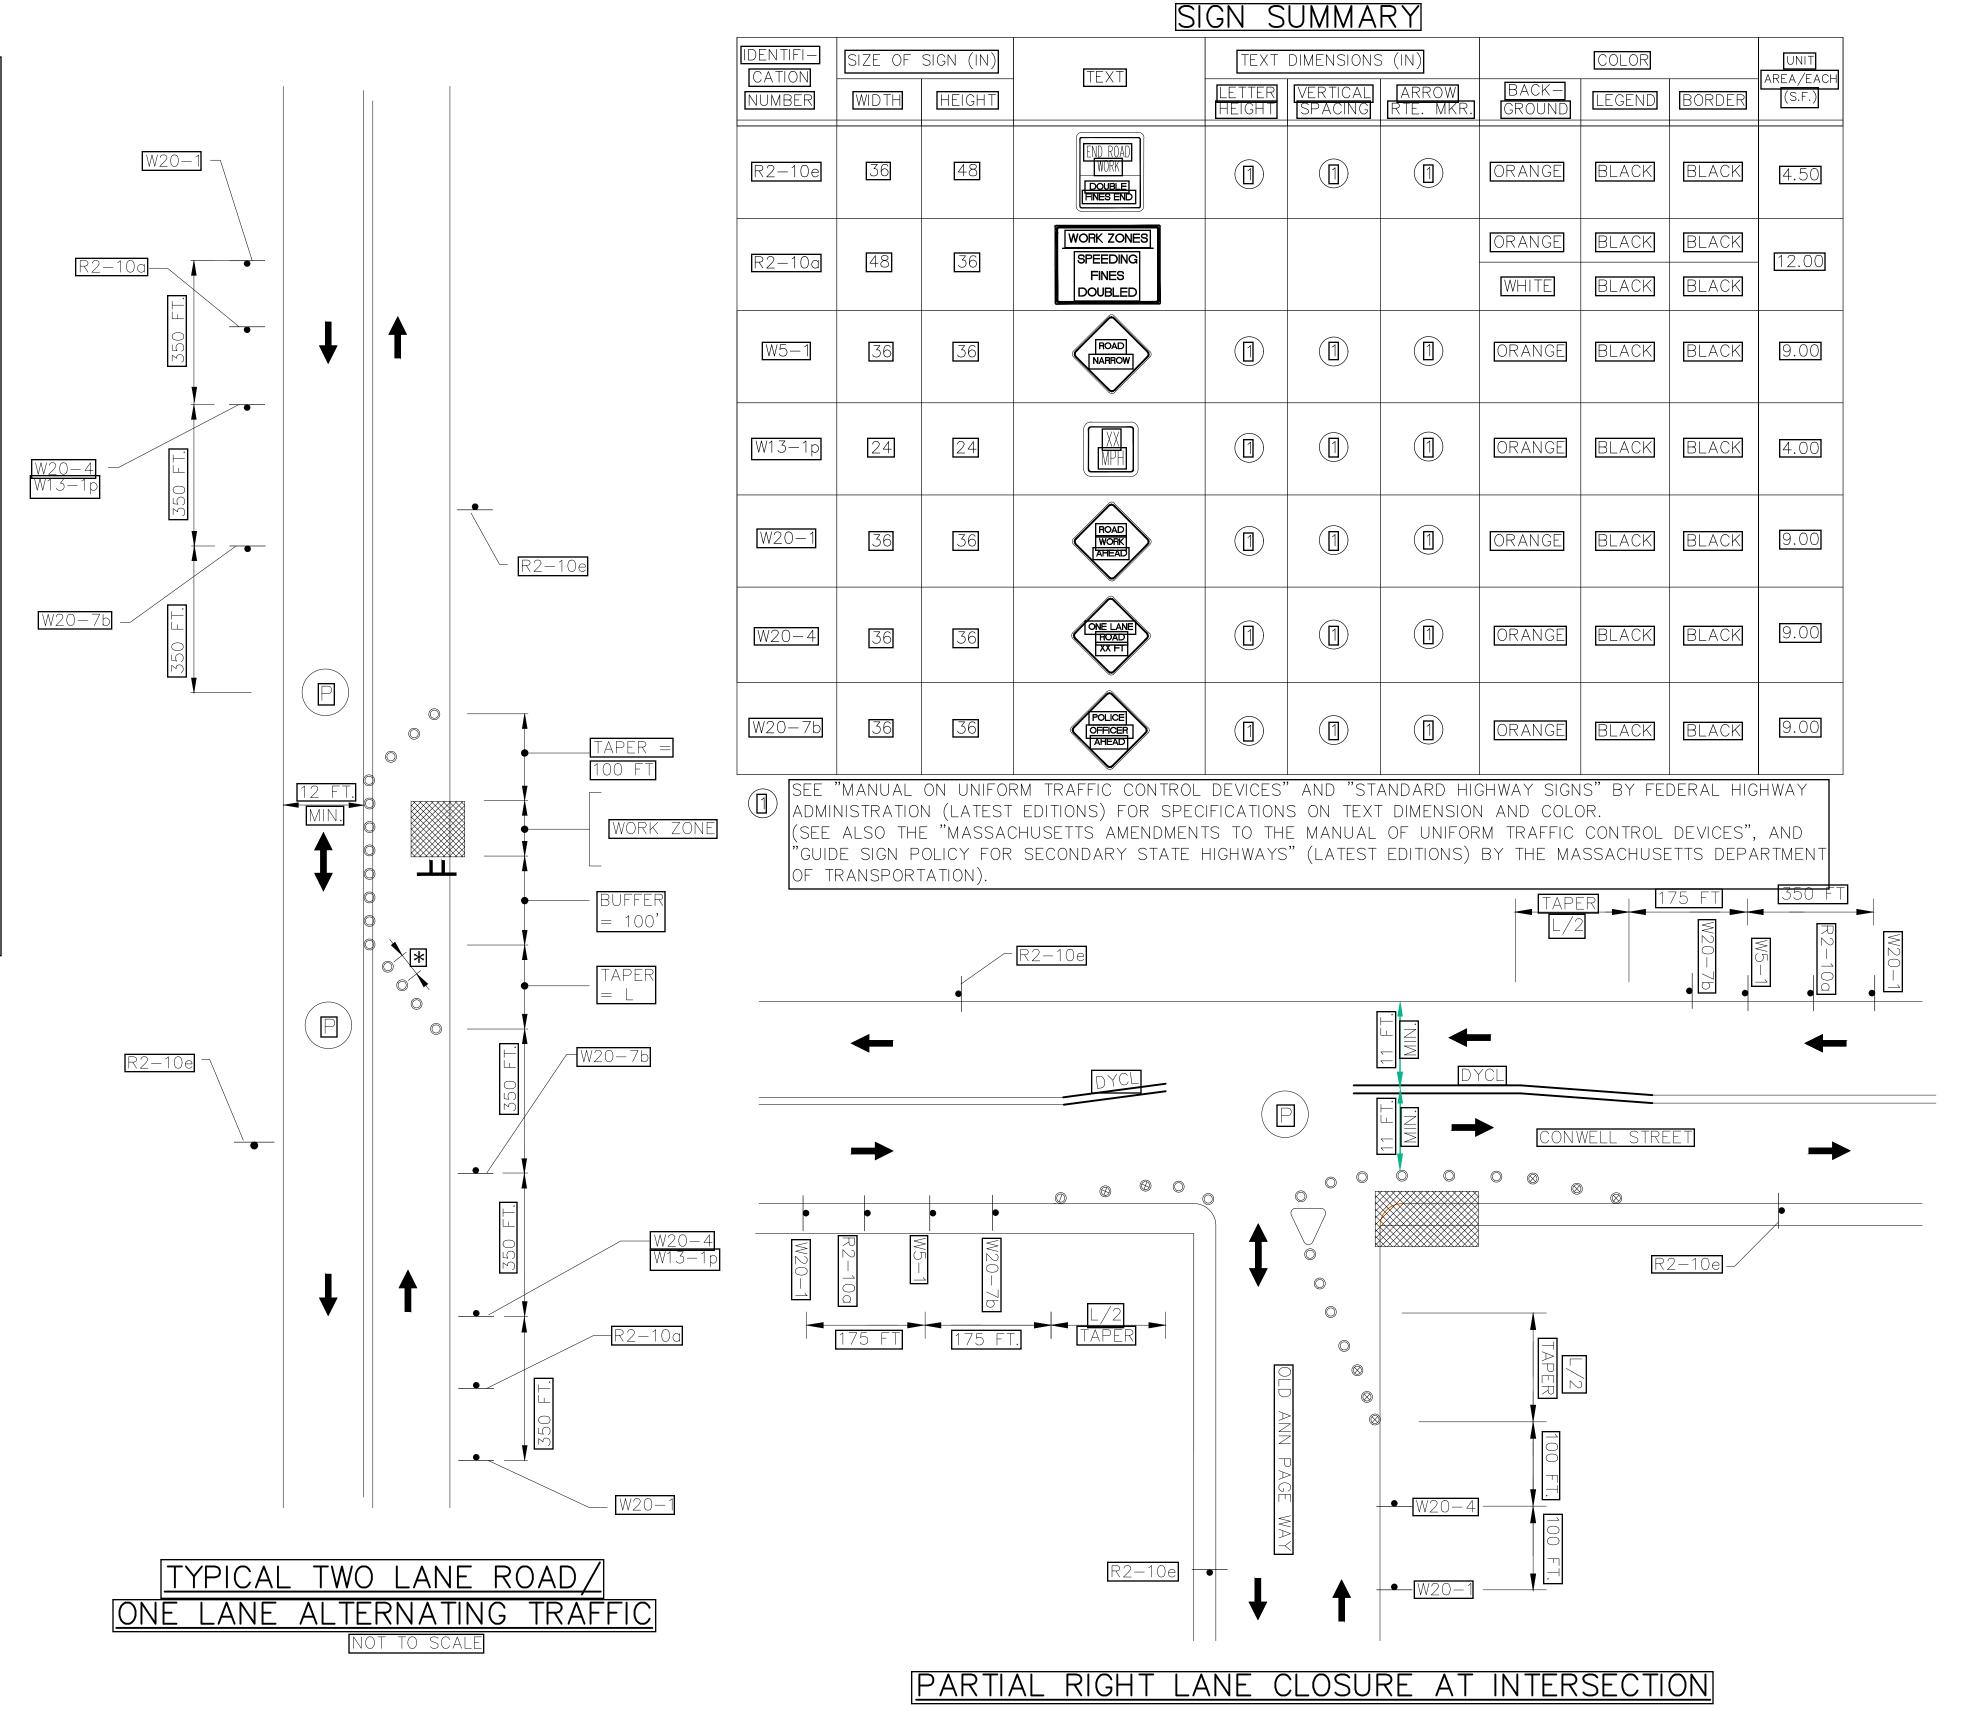
FOR PERMITTING ONLY

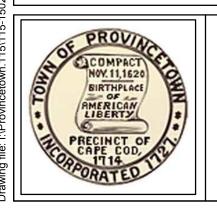
Sheet No.

GENERAL TRAFFIC MANAGEMENT NOTES:

- 1. CONSTRUCTION WILL BE LIMITED TO 9:00 A.M. TO 3:30 P.M. MONDAY THROUGH FRIDAY.
- 2. AT THE END OF EACH CONSTRUCTION DAY NO TRAFFIC CONTROL DEVICES SHALL REMAIN IN THE ROADWAY; ROADWAYS WILL BE PATCHED OR PLATED AND OPEN TO TRAVEL. AT THE END OF EACH WORK WEEK, EXCAVATIONS WILL BE BACKFILLED, COMPACTED AND PAVED AND TEMPORARY PAVEMENT MARKINGS PROVIDED WHERE APPROPRIATE.
- 3. THE CONTRACTOR SHALL INSTALL AND MAINTAIN TRAFFIC CONTROL DEVICES AS NECESSARY AND IN ACCORDANCE WITH THE MANUAL ON UNIFORM TRAFFIC CONTROL DEVICES AND MASSDOT STANDARDS.
- 4. TEMPORARY CONSTRUCTION SIGNING AND ALL OTHER TRAFFIC CONTROL DEVICES SHALL BE IN PLACE PRIOR TO THE START OF ANY WORK.
- 5. THE CONTRACTOR MUST MAINTAIN ACCESS AND EGRESS AT ALL TIMES TO ALL PROPERTIES AND ROADWAYS ABUTTING THE WORK ZONE UNLESS OTHERWISE APPROVED BY THE OWNER AND/OR ENGINEER.
- 6. ALL DISTANCES MAY BE ADJUSTED TO FIT FIELD CONDITIONS, AS DIRECTED BY THE ENGINEER. MINIMUM DISTANCES HOWEVER SHOULD BE MAINTAINED WHERE INDICATED.
- 7. MINIMUM LANE WIDTHS CONSIST OF THE CLEARANCE BETWEEN CHANNELIZING DEVICES SUCH AS DRUMS AND SHALL BE PROVIDED AT ALL TIMES.
- 8. EXISTING PEDESTRIAN WALKWAYS WILL REMAIN OPEN AND CLEAR OF DEBRIS. PEDESTRIANS WILL BE PROTECTED FROM CONSTRUCTION USING THE APPROPRIATE SAFETY MEASURES AS DIRECTED BY THE ENGINEER. SUCH MEASURES WILL BE CONSIDERED INCIDENTAL TO THE PROJECT. IN LOCATIONS WHERE EXISTING PEDESTRIAN WALKWAYS HAVE BEEN IMPACTED BY CONSTRUCTION, THE ENTIRE WIDTH OF THE PEDESTRIAN WALKWAY IS TO BE RECONSTRUCTED IN KIND WITH A MINIMUM WIDTH OF 5 FEET EXCLUDING CURBING.
- 9. MAXIMUM SPACING OF CHANNELIZING DEVICES IS EQUAL (IN FEET) TO THE SPEED LIMIT (MPH).
- 10. CHANNELIZATION WILL BE ACCOMPLISHED THROUGH THE USE OF REFLECTORIZED PLASTIC DRUMS. PLASTIC DRUMS WITH ANY FORM OF LIGHTING DEVICE MOUNTED ON THEM MUST PASS THE CRITERIA AS SET FORTH IN NCHRP 350 "RECOMMENDED PROCEDURES FOR THE SAFETY PERFORMANCE EVALUATION OF HIGHWAY FEATURES."
- 11. THE FIRST FIVE PLASTIC DRUMS OF A TAPER SHALL BE MOUNTED WITH TYPE A LIGHTS.
- 12. FLASHING WARNING LIGHTS AND/OR FLAGS MAY BE USED ON ADVANCE WARNING SIGNS AS DIRECTED BY THE ENGINEER. FLAGS SHALL BE A MINIMUM OF 16" X 16".
- 13. ALL SIGNS SHALL BE MOUNTED ON THEIR OWN STANDARD SIGN SUPPORT.
- 14. ALL TEMPORARY SIGNS AND SIGN SUPPORTS LOCATED ON OR NEAR THE TRAVELED WAY MUST PASS THE CRITERIA SET FORTH IN THE NCHRP 350 REPORT "RECOMMENDED PROCEDURES FOR THE SAFETY PERFORMANCE EVALUATION OF HIGHWAY FEATURES."
- 15. ALL TEMPORARY TRAFFIC CONTROL DEVICES AND ADVANCE WARNING SIGNS SHALL BE REMOVED IMMEDIATELY WHEN NO LONGER NEEDED.









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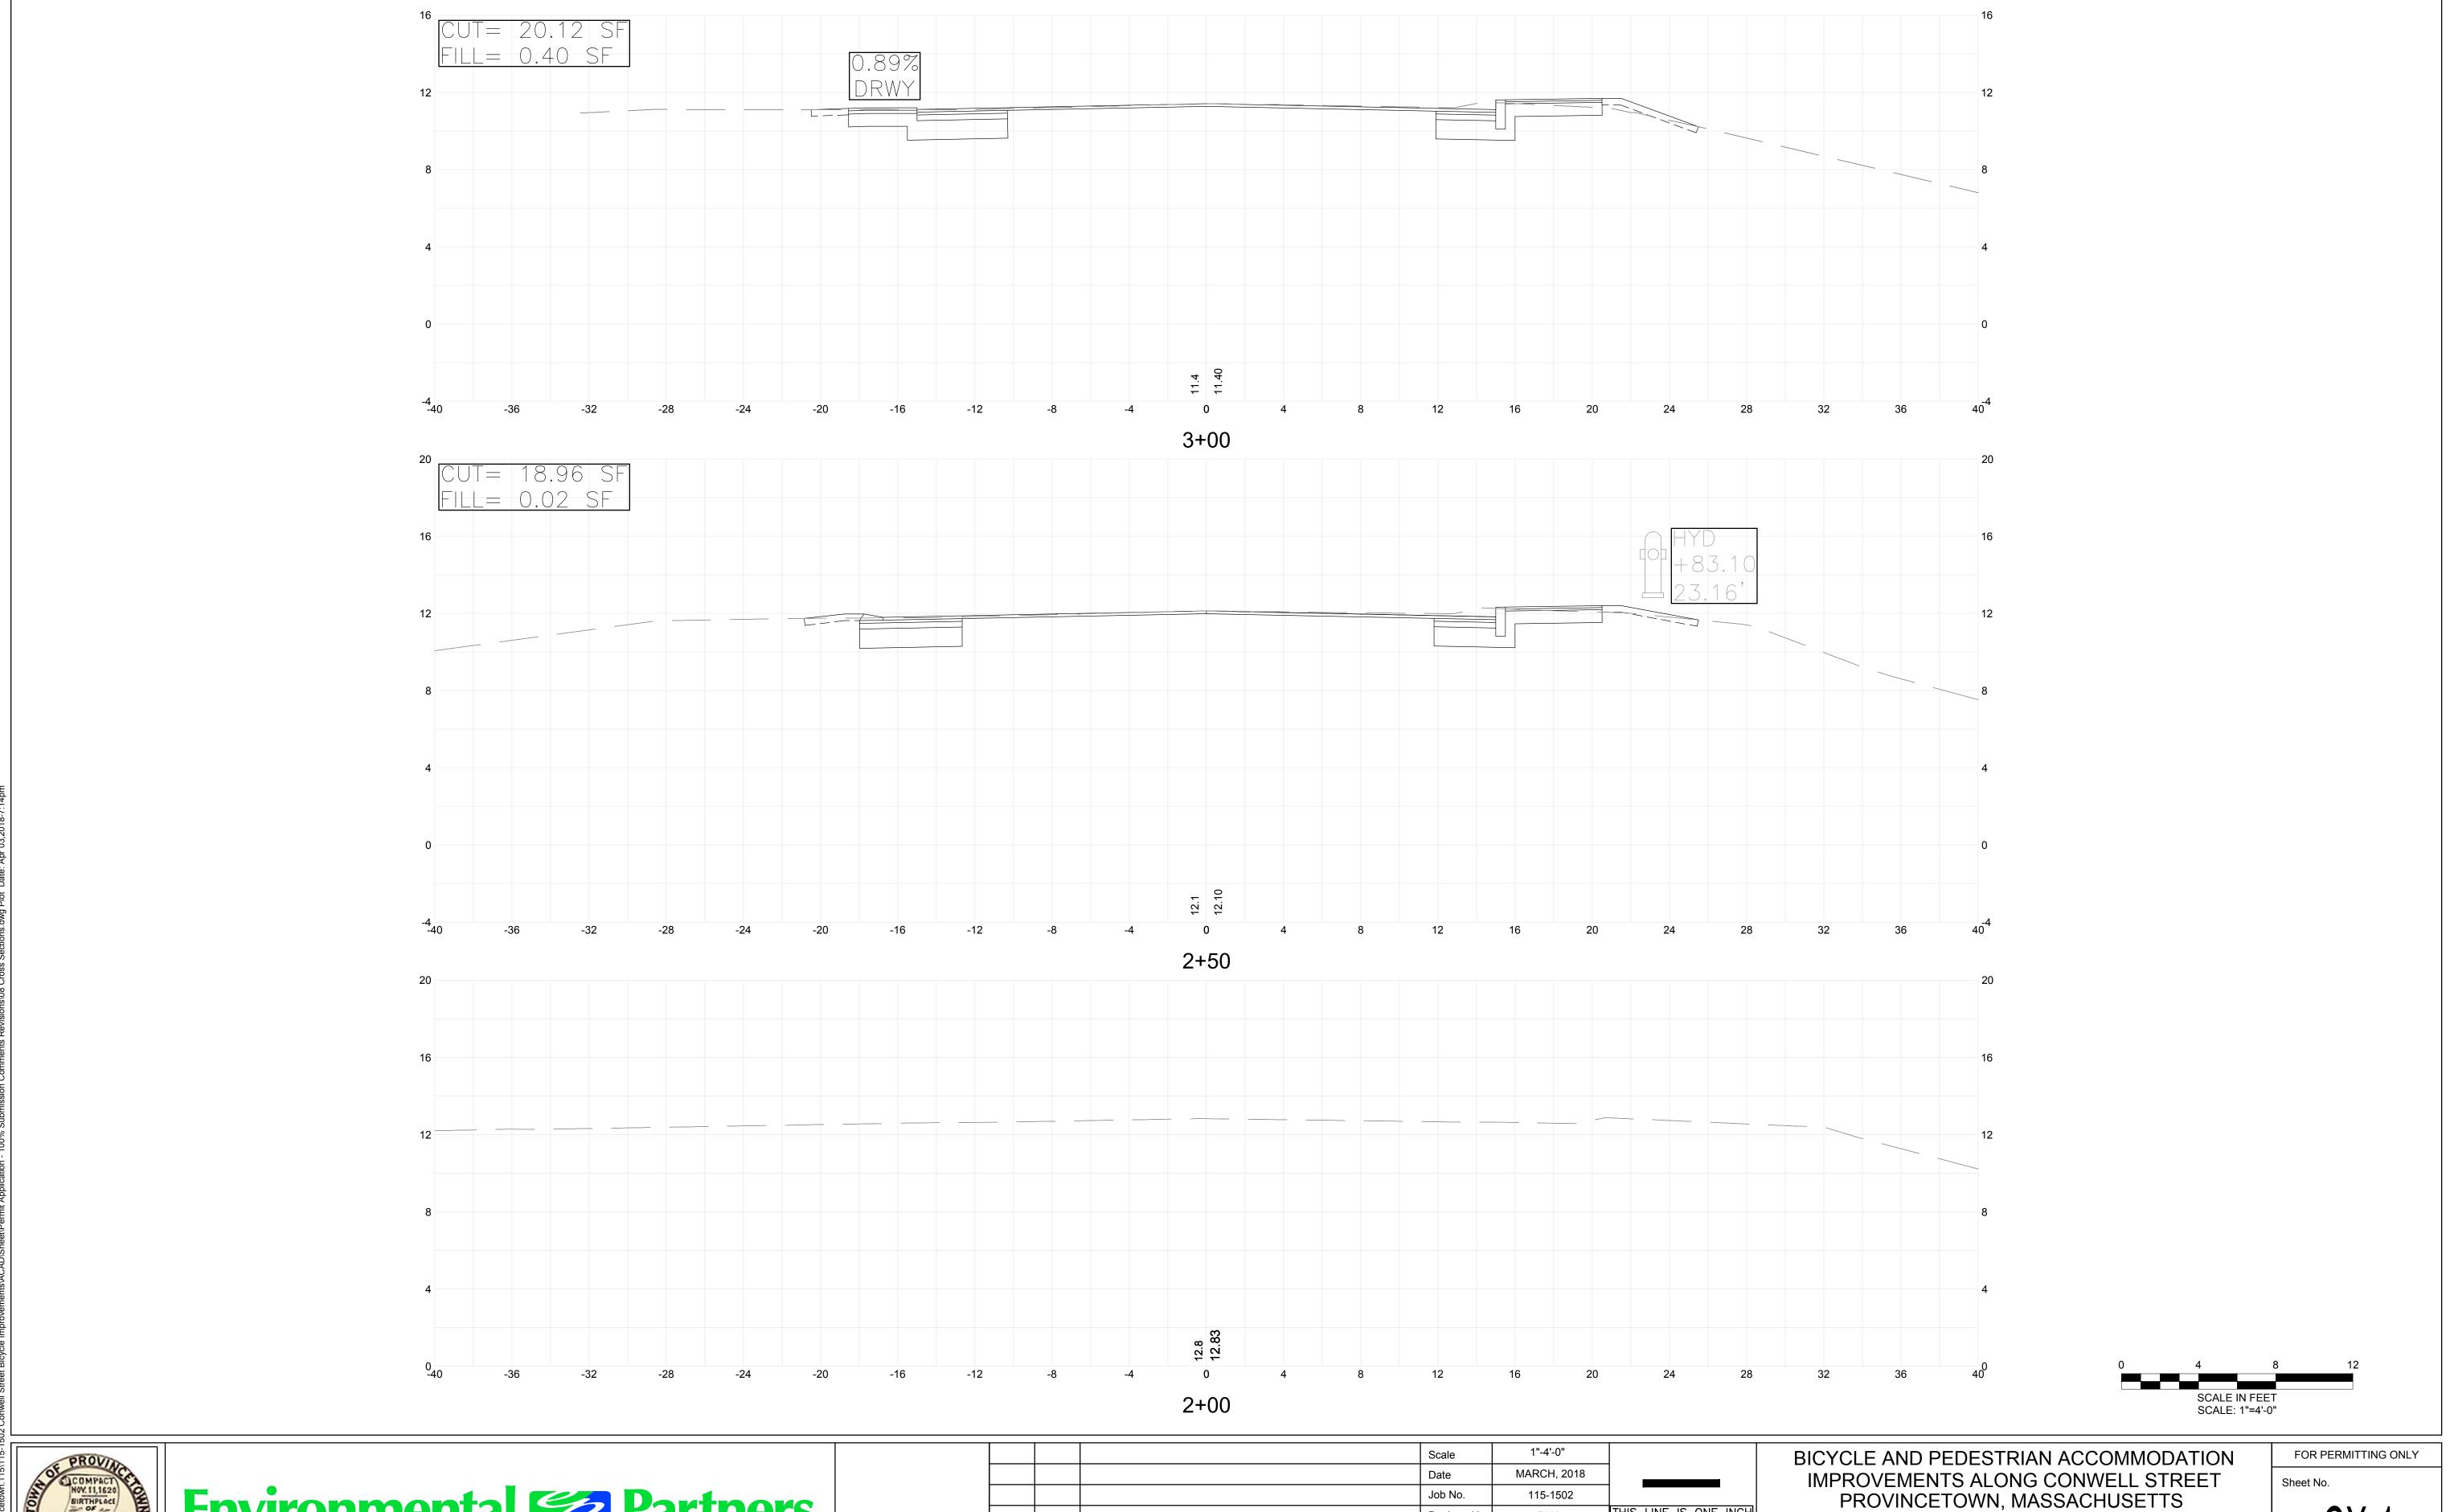
BICYCLE AND PEDESTRIAN ACCOMMODATION IMPROVEMENTS ALONG CONWELL STREET PROVINCETOWN, MASSACHUSETTS

NOT TO SCALE

Sheet No.

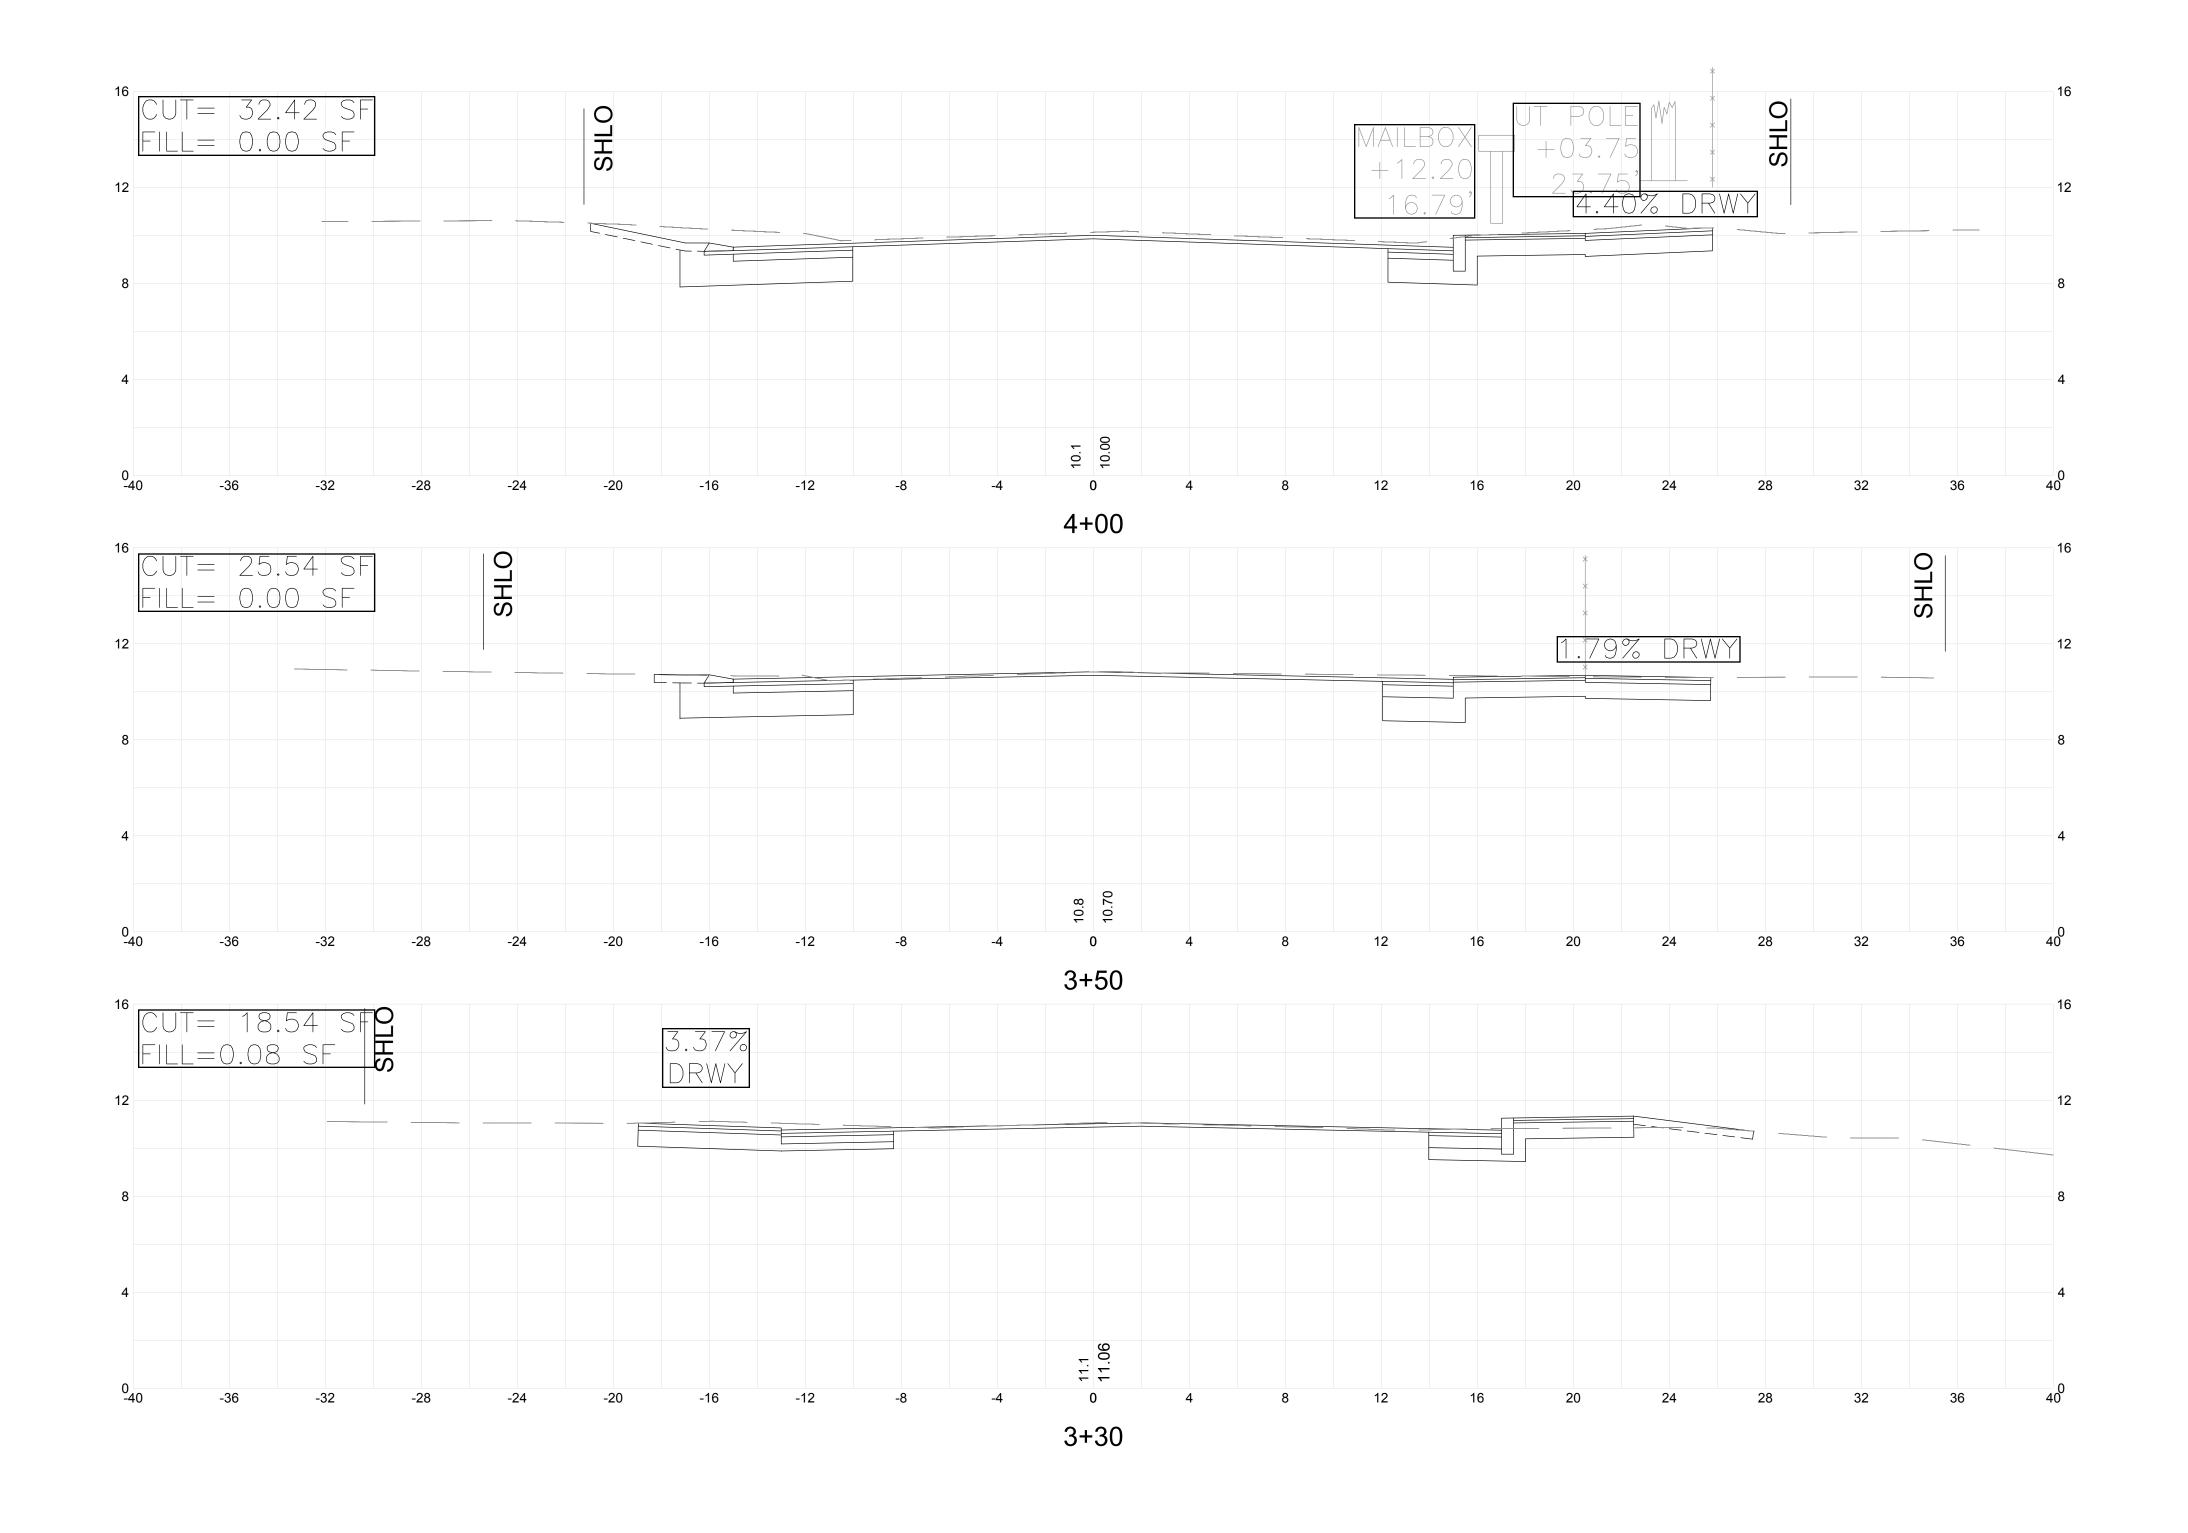
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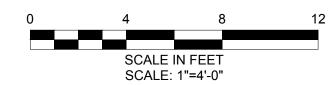
TRAFFIC MANAGEMENT PLAN



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			Date	MARCH, 2018	
			Job No.	115-1502	
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IMPROVEMENTS ALONG CONWELL STREET PROVINCETOWN, MASSACHUSETTS









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CROSS SECTIONS #2
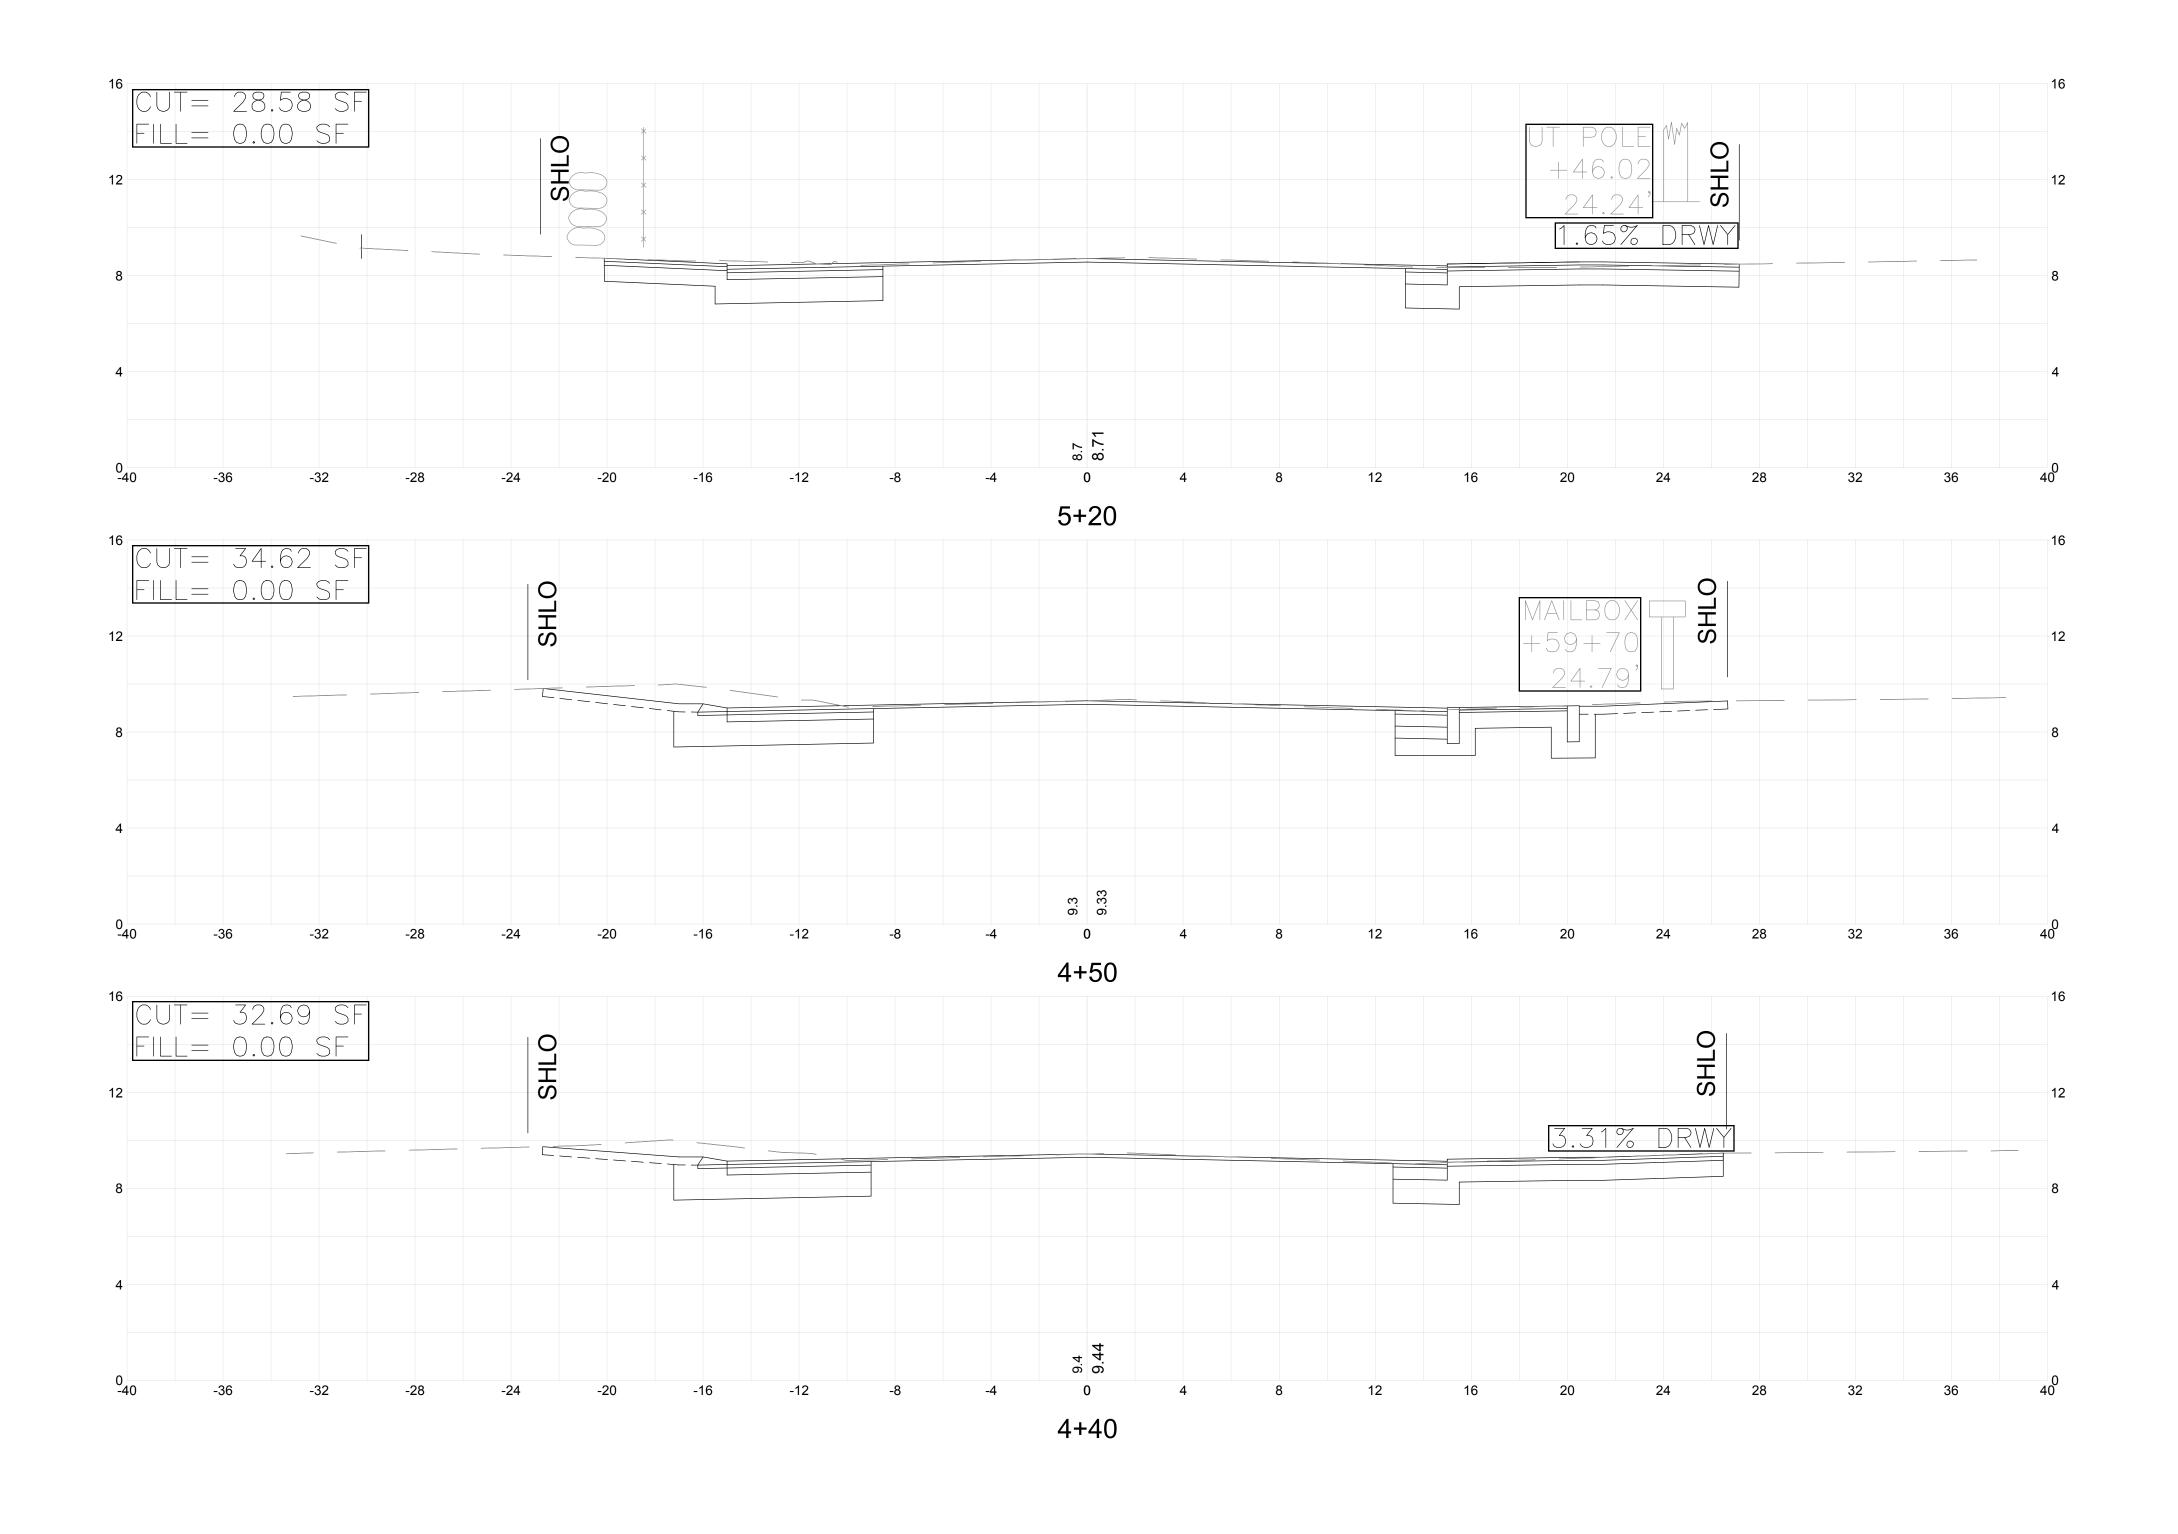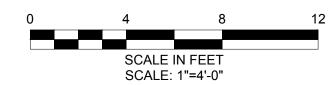
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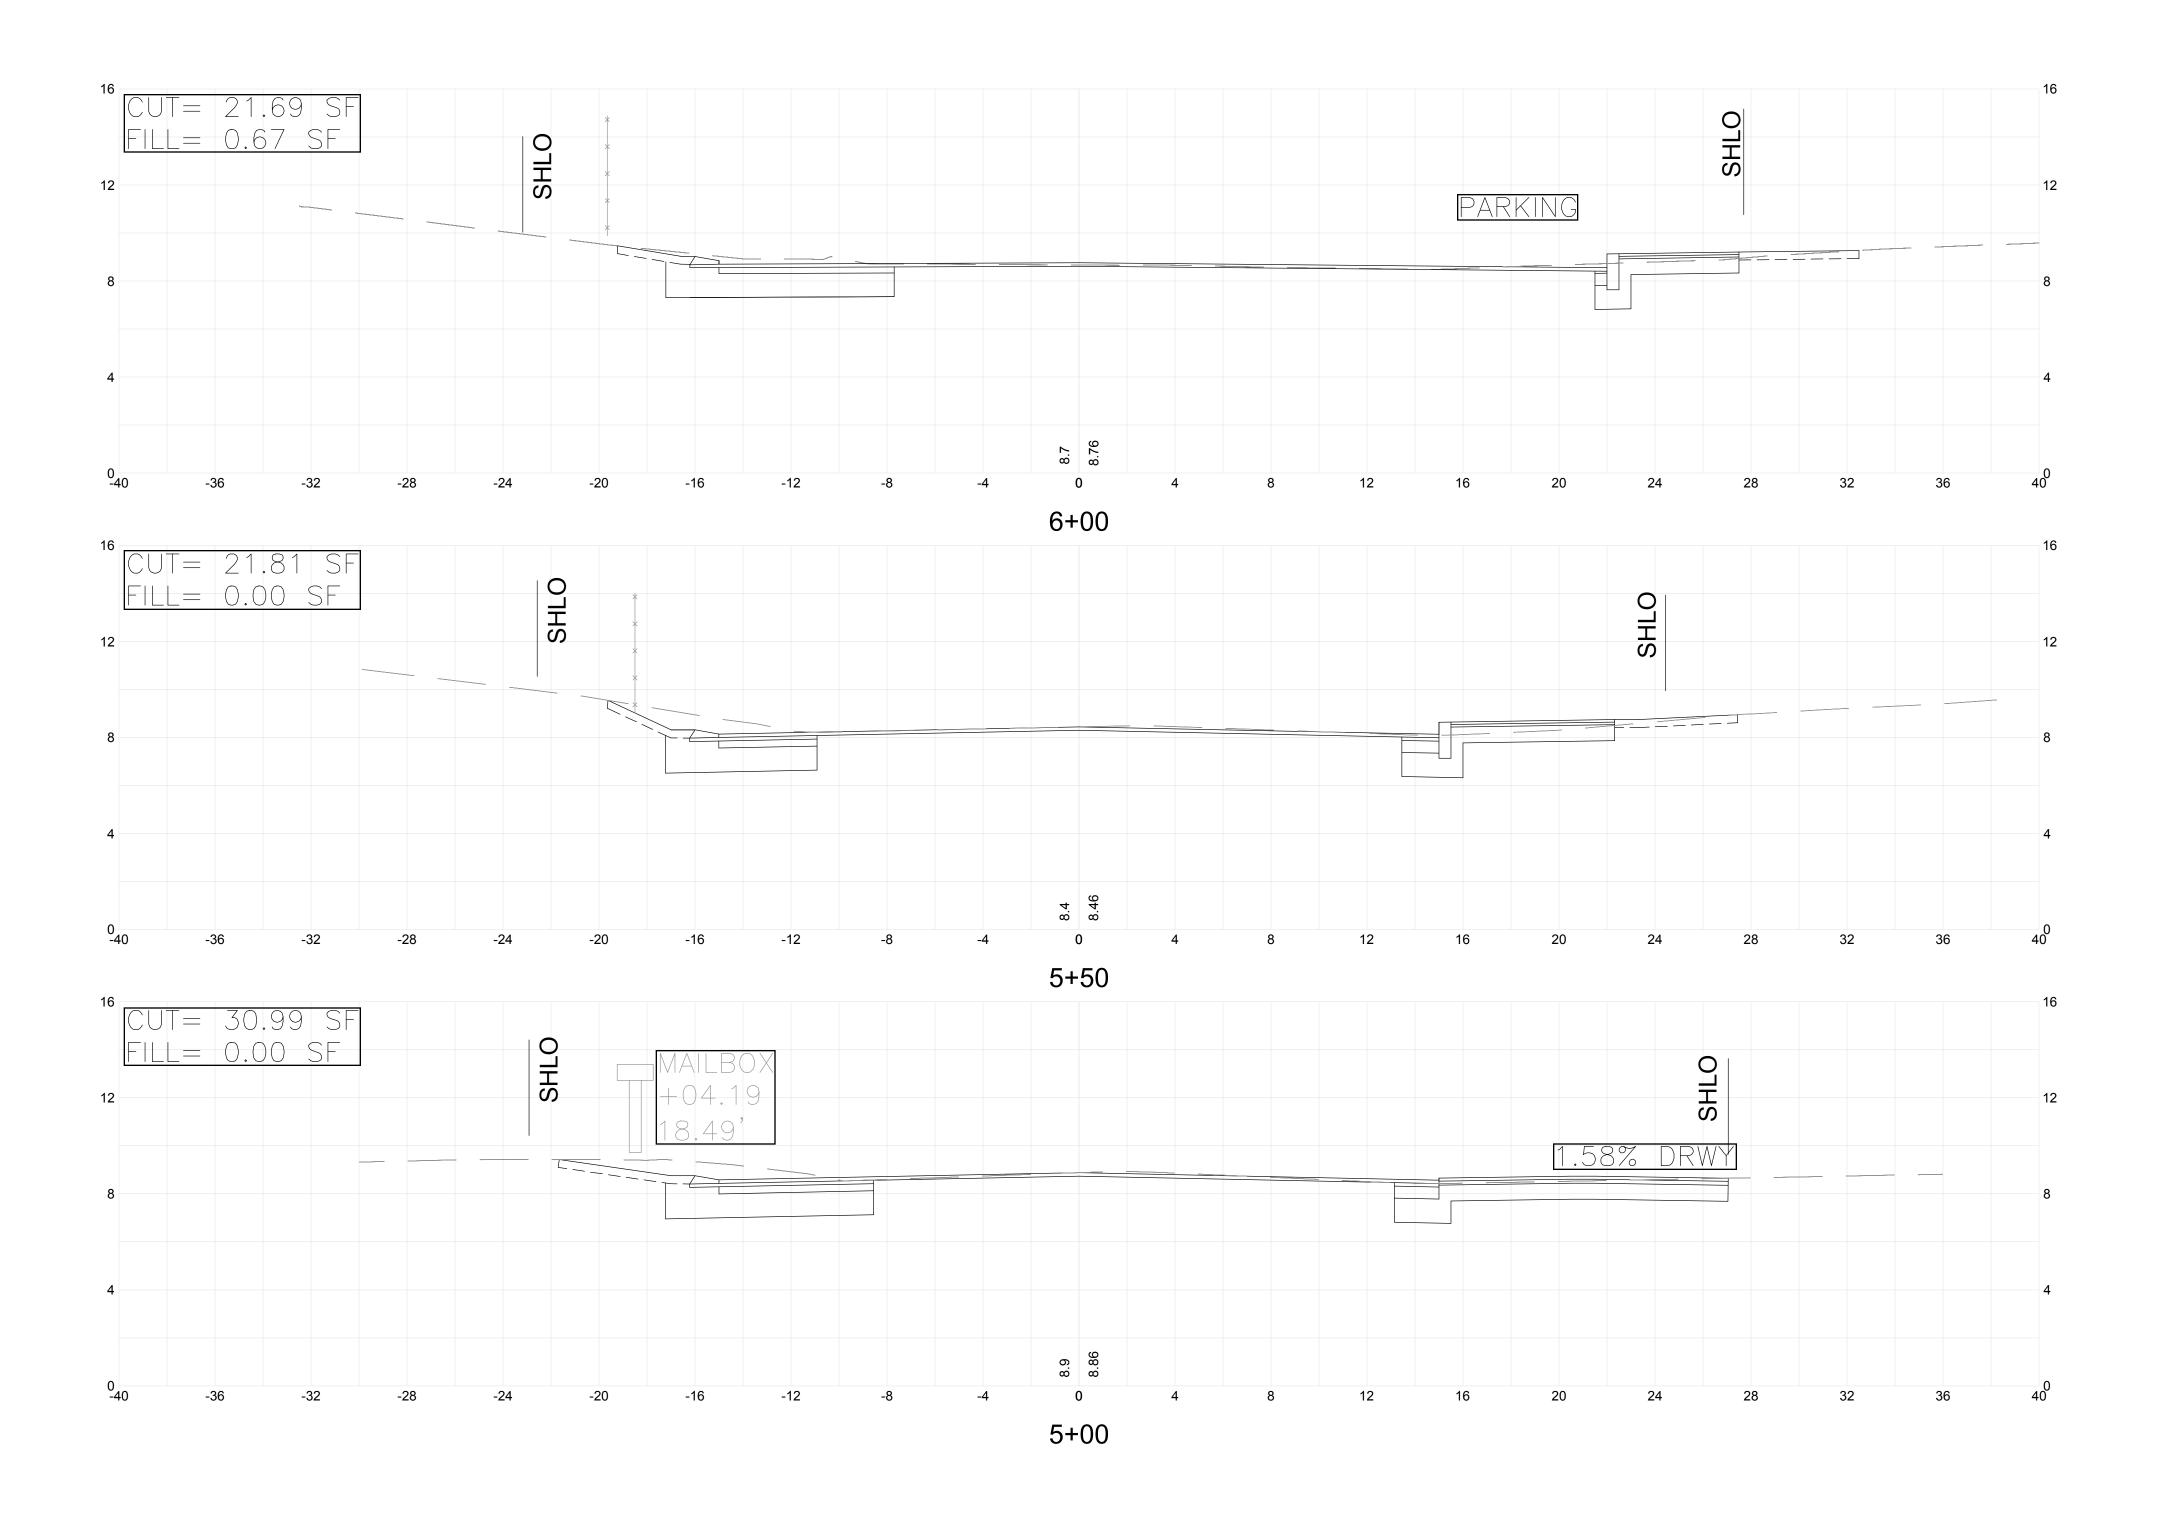



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CROSS SECTIONS #3

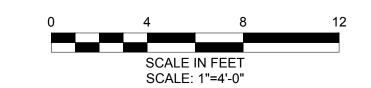Sheet No.

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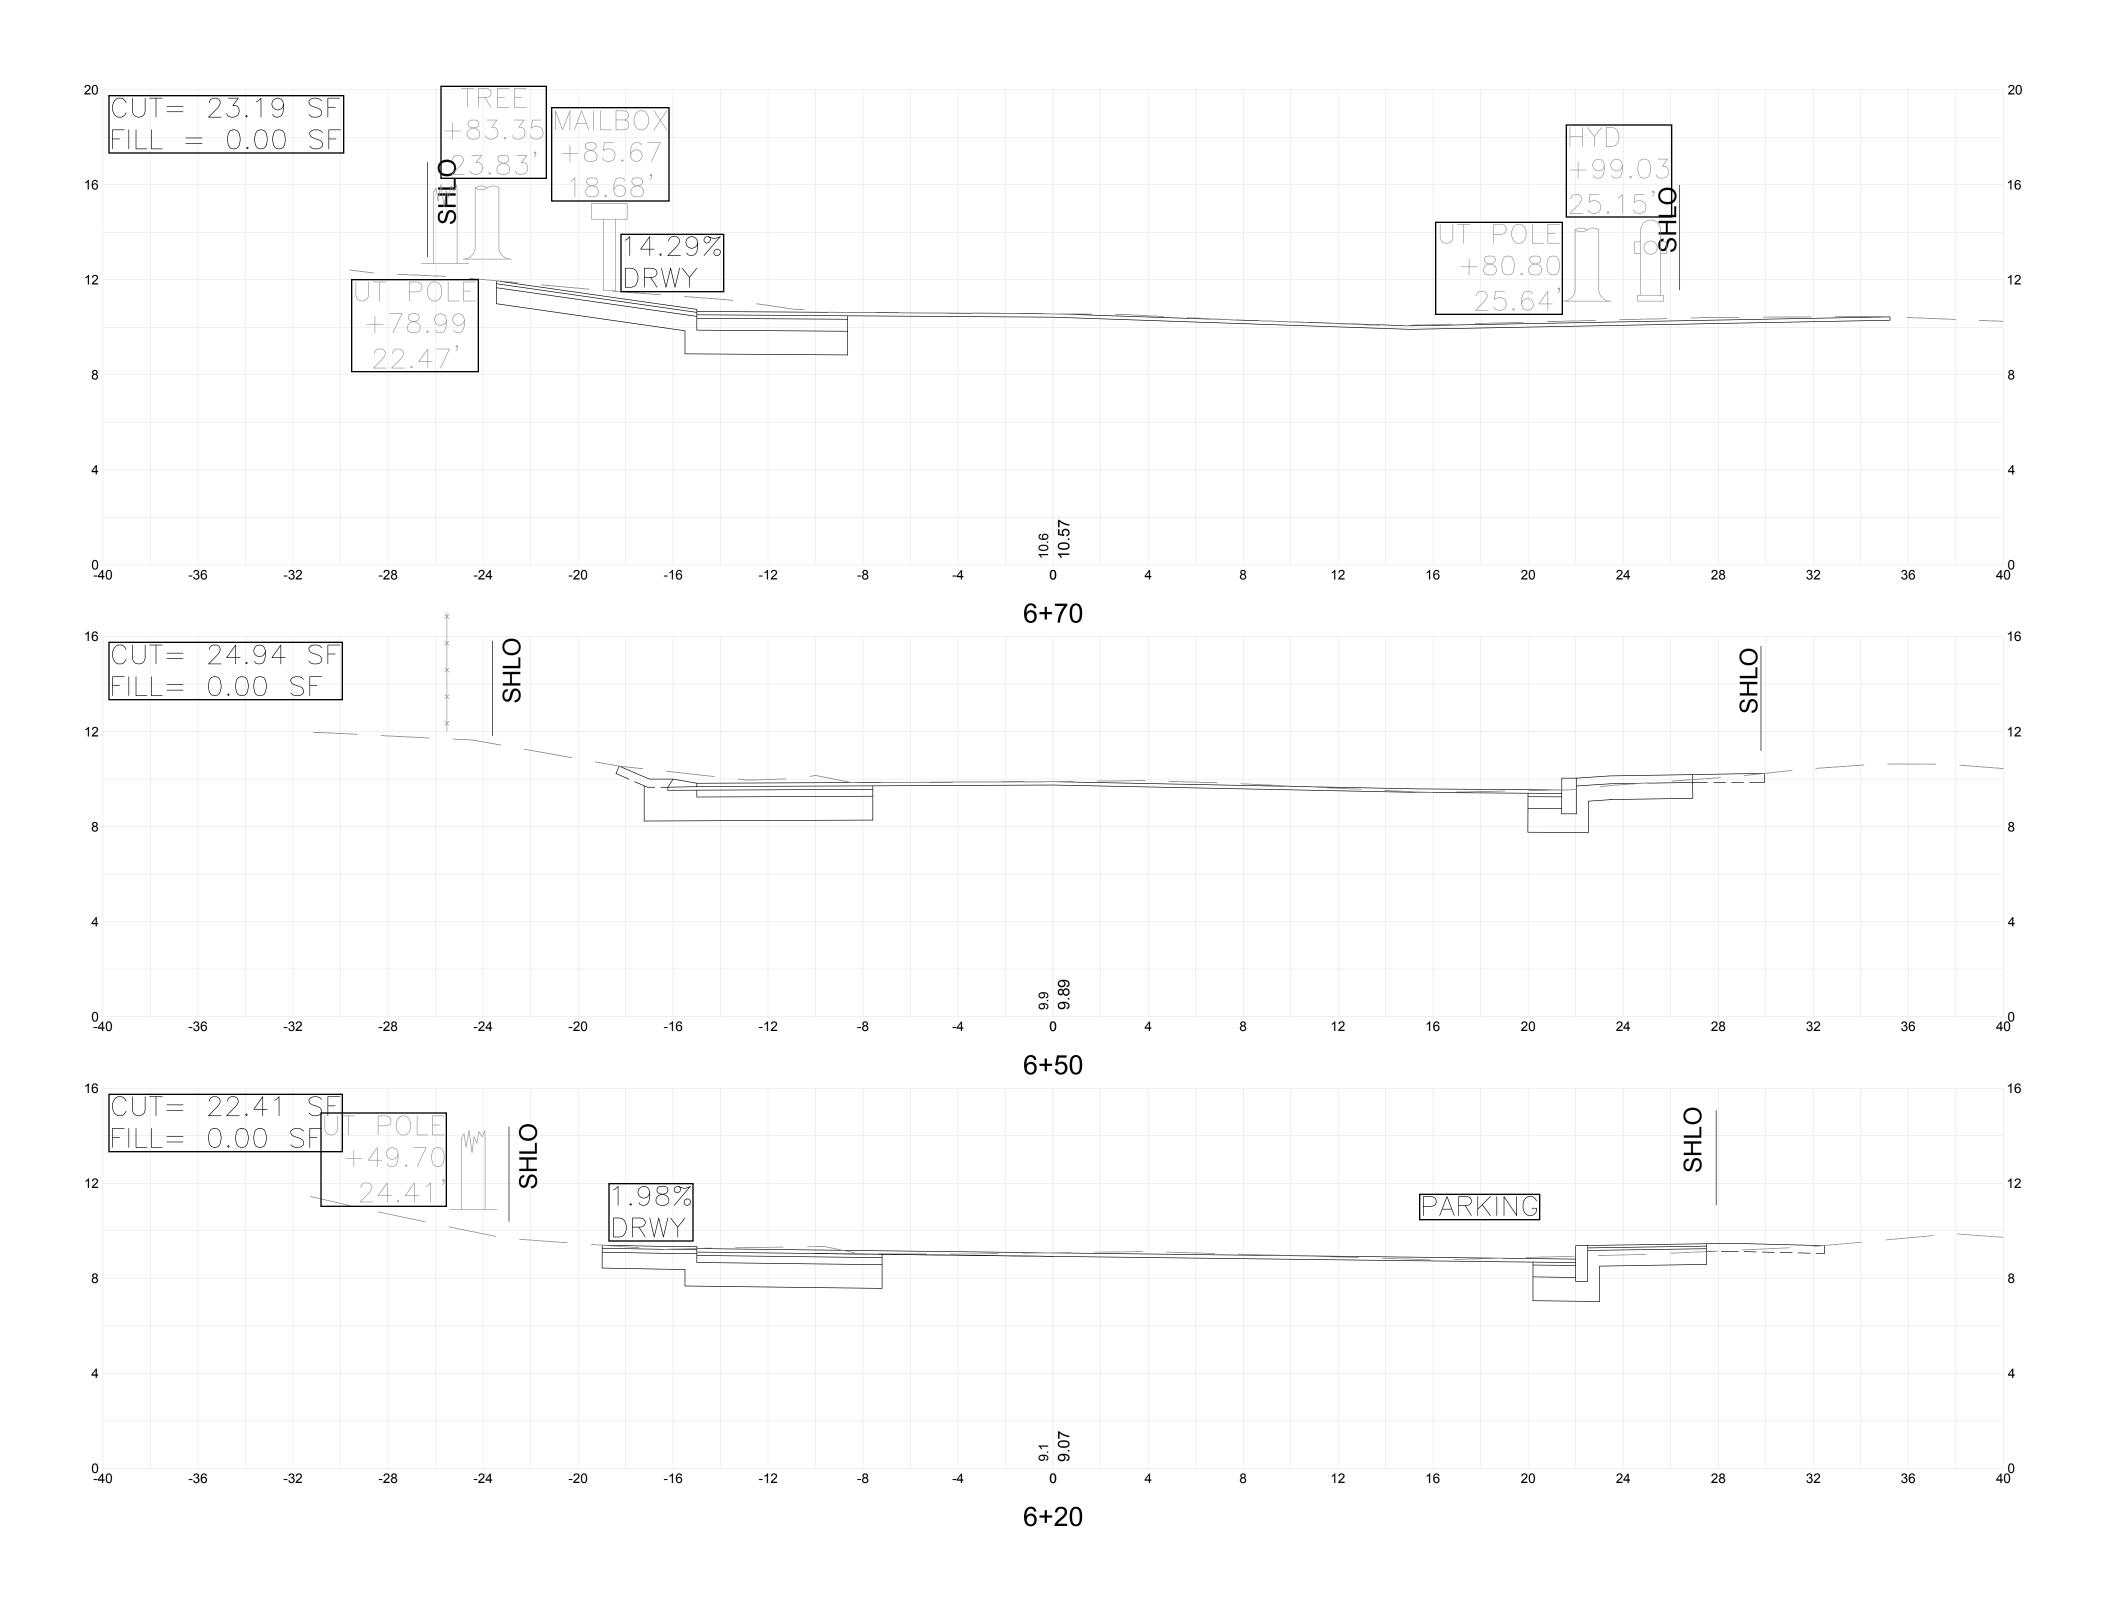
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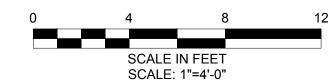
OSS SECTIONS #4

CROSS SECTIONS #4

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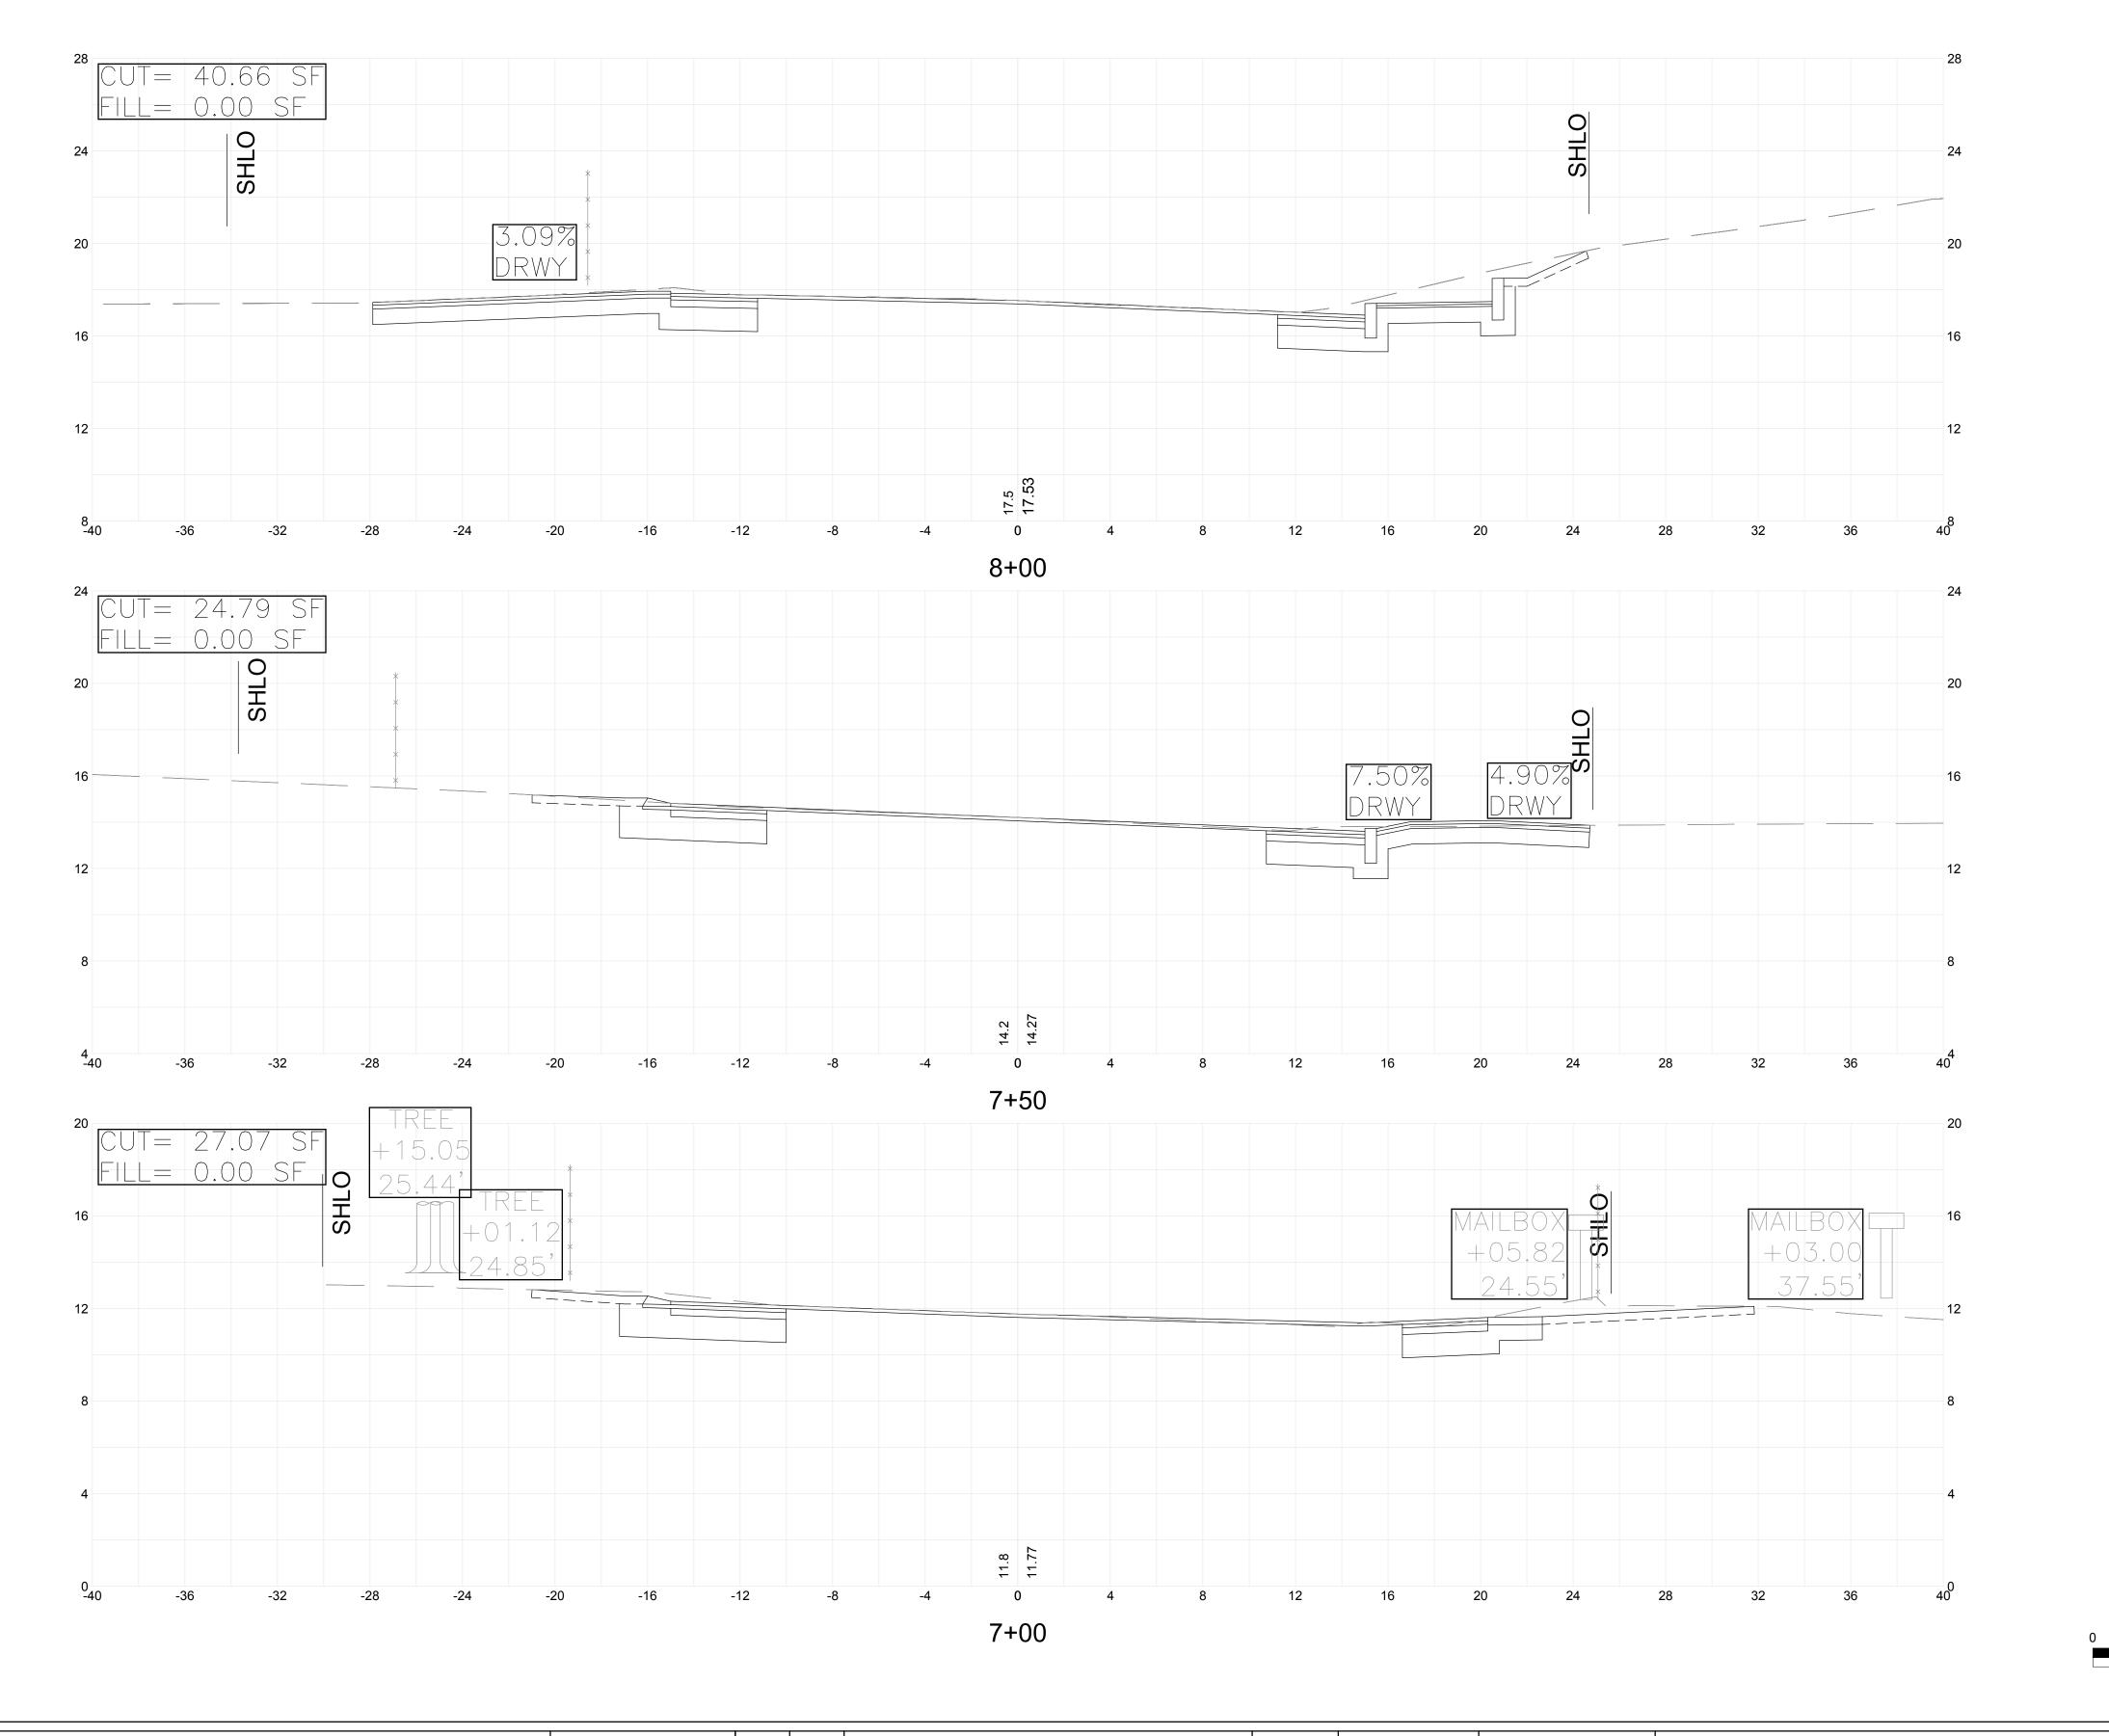




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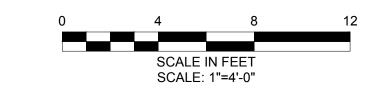
CX-6

Sheet No.

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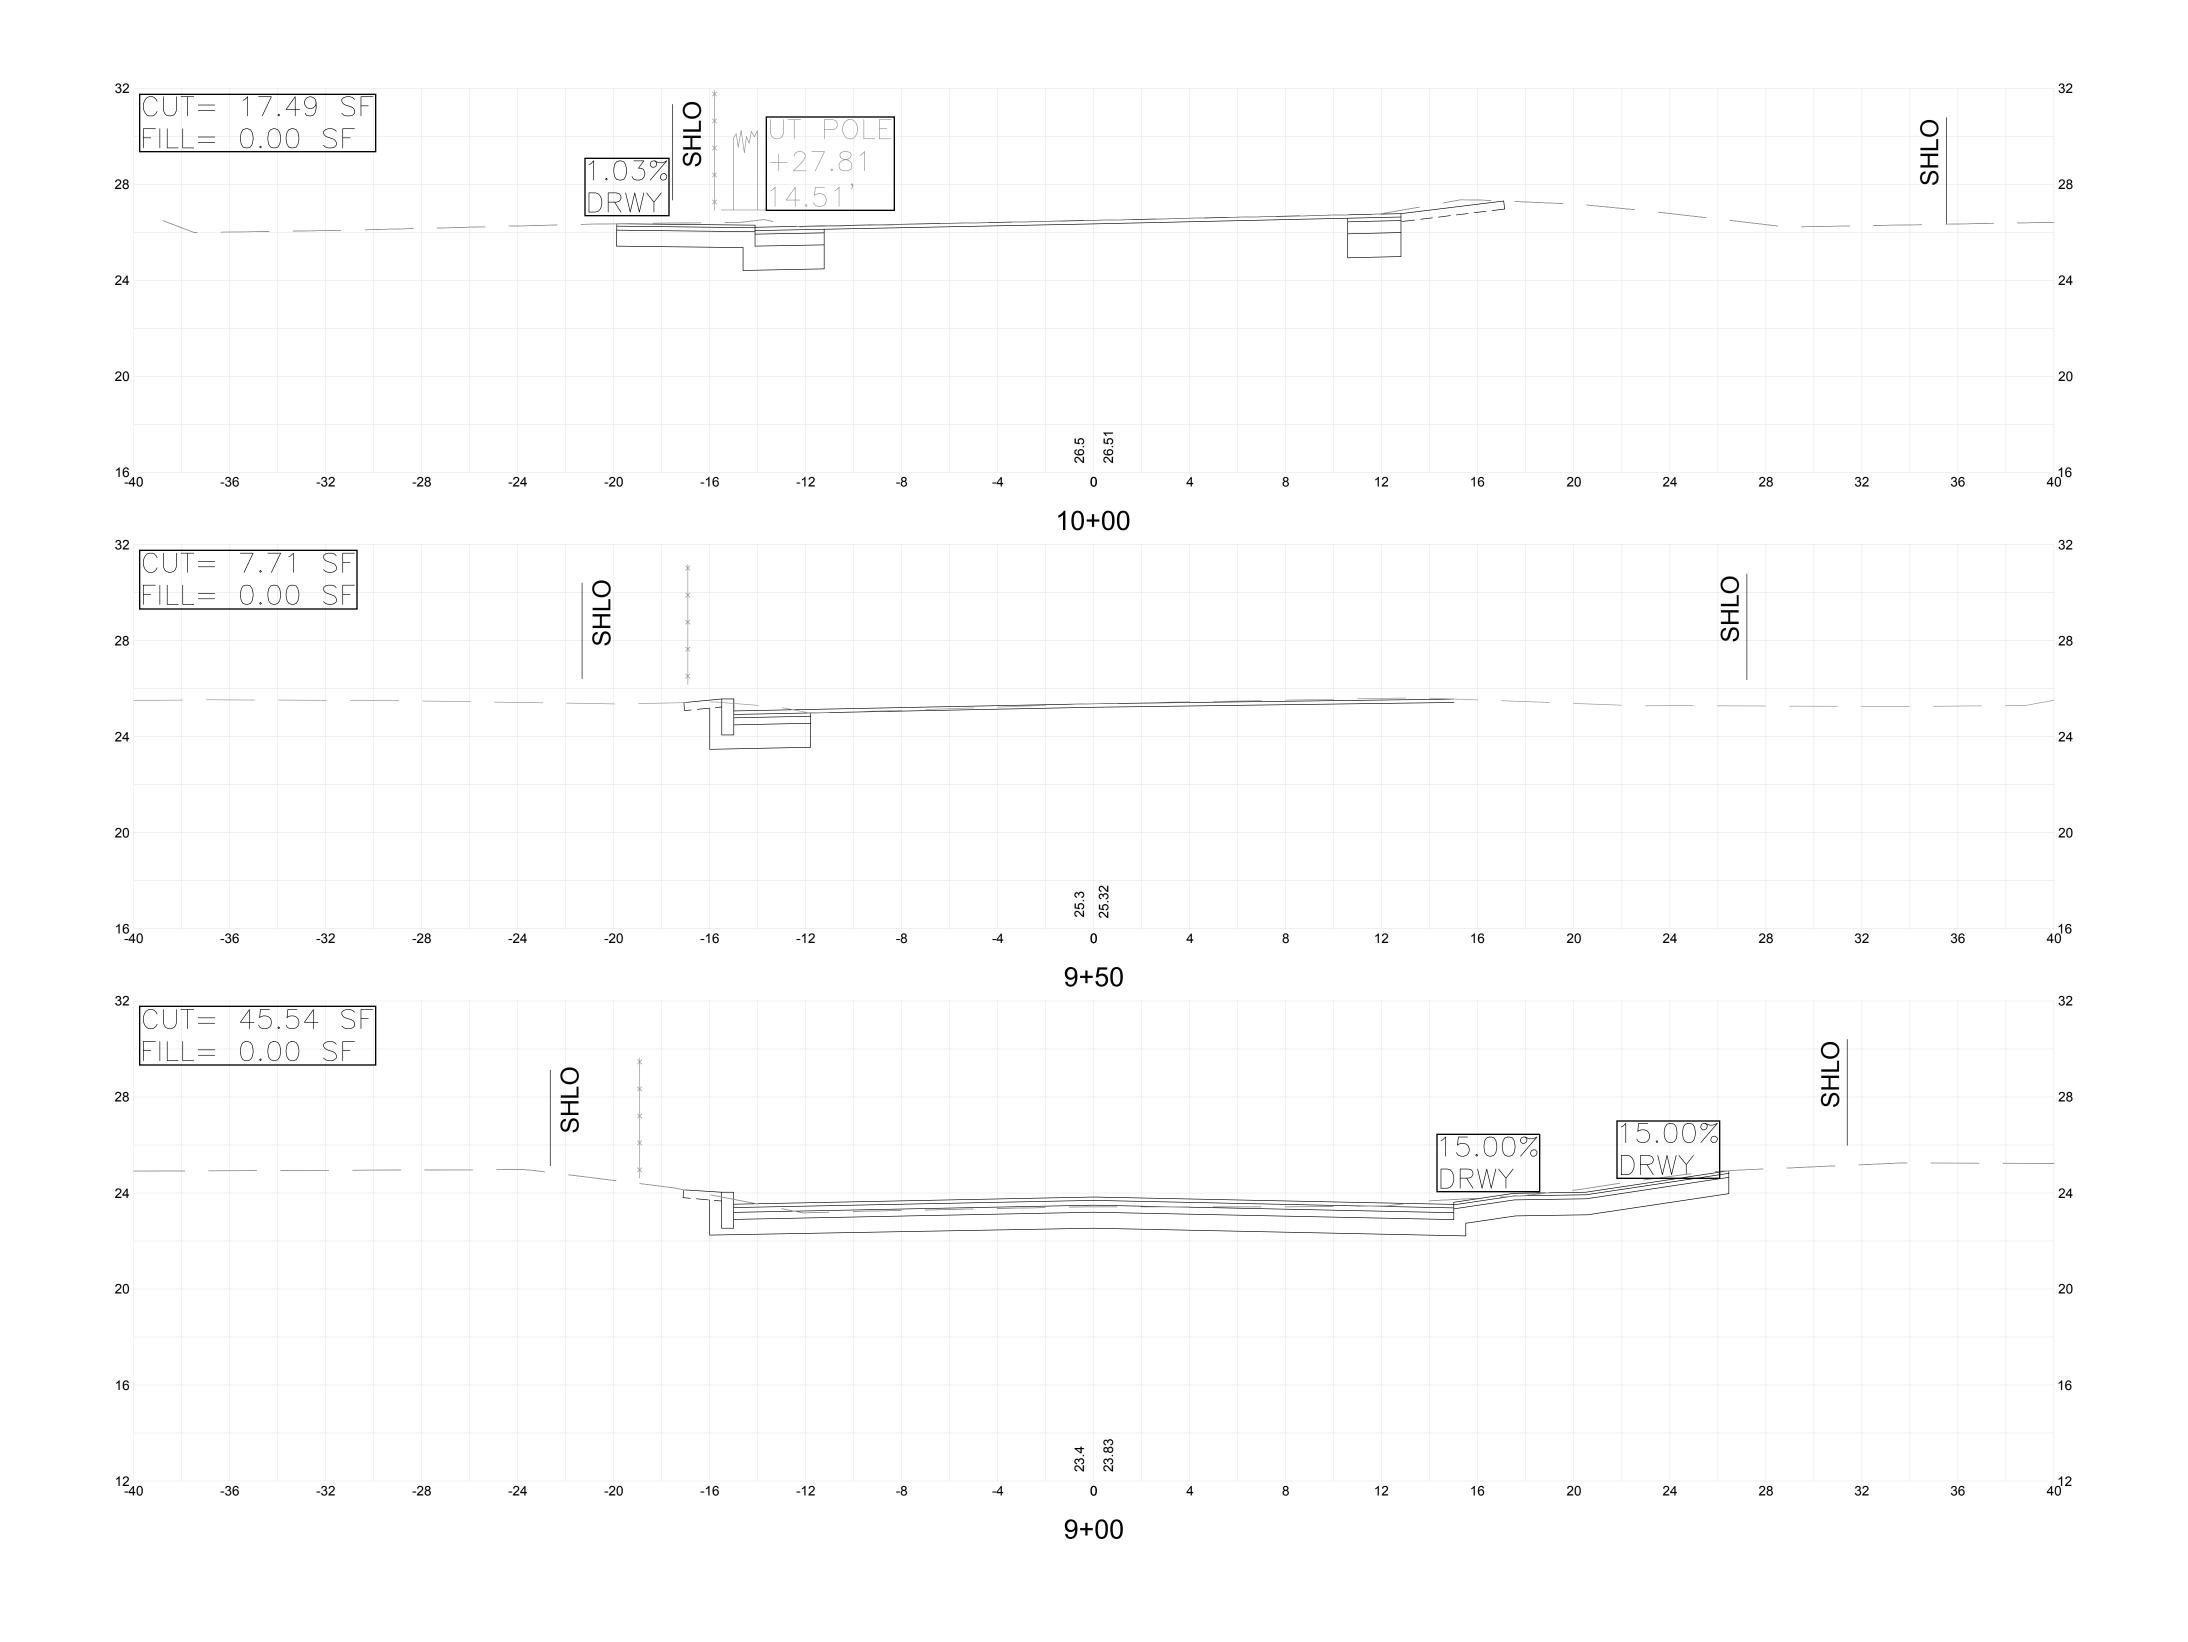





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CROSS SECTIONS #8
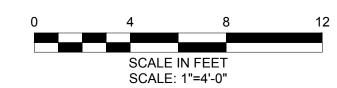
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